
LEGEND

EXISTING	PROPOSED	LABEL
		PARCEL BOUNDARY
		ADJACENT BOUNDARY
		EASEMENT - PUBLIC UTILITY
— — 4 654 — —	4656 ——	MAJOR CONTOUR
	4655.50	MINOR CONTOUR
XX.XX	XX.XX	GRADE SPOT ELEVATION
		CONTROL POINT
•		FOUND $\frac{5}{8}$ " IRON ROD WITH YELLOW PLASTIC CAP STAMPED "FRED ASAT JR", UNLESS NOTED OTHERWISE
•		FOUND 5" IRON ROD WITH DAMAGED YELLOW PLASTIC CAP
(P)		BEARING AND DISTANCE PER
(M)		PARTITION PLAT NO. 200819 MEASURED BEARING & DISTANCE
(C)		CALCULATED BEARING & DISTANCE
- o-	- o -	SIGNAGE
		ASPHALT PAVEMENT
		BUILDING
	A A A A A	CONCRETE
		GRAVEL ROAD
		ROOFLINE
XX		FENCE
0	0	BOLLARD
	*	DECIDUOUS TREE
		CURB - FLOWLINE
		CURB - TOP BACK OF CURB
\$	**	FIRE HYDRANT
M	\overline{W}	WATER METER
₩v	₩	WATER VALVE
	——w———w——	WATER LINE
		WATER SERVICE
	FIRE	FIRE SERVICE
——IR ———IR ———		IRRIGATION PIPE
		IRRIGATION CONTROL VALVE
©	⊗	SANITARY SEWER CLEANOUT
\$	\$	SANITARY SEWER MANHOLE
	ss	SANITARY SEWER MAIN
	——\$\$———\$\$——	SANITARY SEWER SERVICE
SS FM —	SS FM —	PRESSURIZED SAN SEWER SERVICE
———— SD — — ——	——SD———SD——	STORM DRAIN
	—RD—RD—	
		PERFORATED DRAIN PIPE
(W)	()	DRY WELL
•••••	(B)	STORM CATCH BASIN
		STORM DRAIN INLET
(D)		STORM SEWER MANHOLE
$\overline{\mathbb{N}}$		CABLE TV PEDESTAL
		BURIED TELEVISION
		ELECTRICAL METER
E - ⊕		ELECTRICAL METER GUY POLE
☆	ф	BOLLARD LIGHT POLE
~ O-□	⊙ □	LIGHT POLE
₽ 1	00	POWER POLE
	—— BP ——— BP ———	BURIED POWER LINE
OHP		OVERHEAD POWER LINE
2	UTIL	
F	J.12	BURIED FIBER OPTIC LINE
[G]		GAS METER
NG	NG	
	-	PARKING STRIPE
I		TELEPHONE PEDESTAL
BTBT		BURIED TELEPHONE LINE

OVERHEAD TELEPHONE LINE

——— OH ———

CIVIL SHEET INDEX		
SHEET NUMBER	SHEET TITLE	
C000	GENERAL NOTES	
C010	EXISTING CONDITIONS	
C020	DEMOLITION PLAN	
C110	SITE PLAN	
C120	UTILITY PLAN	
C130	GRADING PLAN	
C500	DETAILS	
C501	DETAILS	
C502	DETAILS	

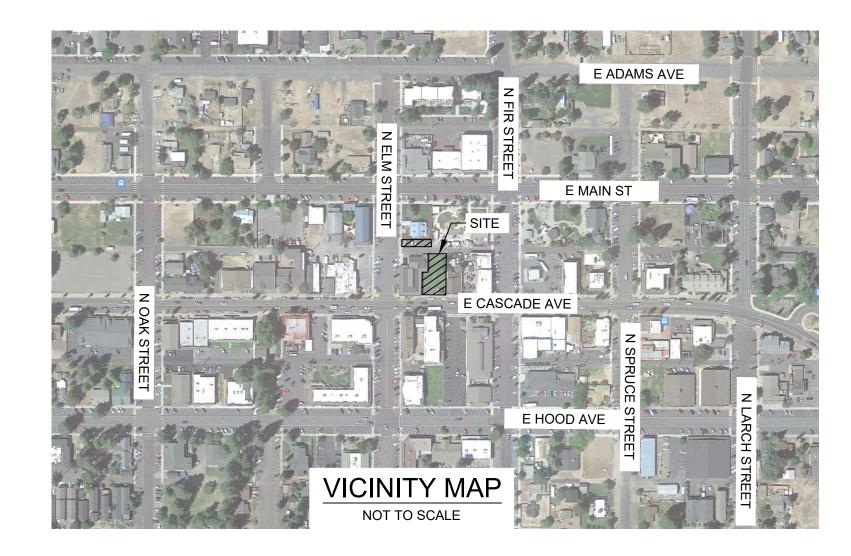

GENERAL NOTES

- IN GENERAL EXISTING STRUCTURES AND FACILITIES ARE NOTED AS "EXISTING" AND ARE SHOWN IN LIGHT LINE WEIGHTS OR AS SCREENED BACKGROUND. NEW STRUCTURES OR FACILITIES ARE SHOWN IN HEAVY LINE WEIGHTS.
- 2. ALL PROFILES REPRESENT EXISTING GROUND (DASHED LINE) AND FINISHED GRADE (SOLID LINE) ALONG THE ALIGNMENT INDICATED ON THE PLANS. ELEVATIONS ARE FINISHED GRADE ELEVATIONS UNLESS OTHERWISE NOTED.
- 3. UTILITY LOCATIONS AND EFFECTS ON WORK ARE RESPONSIBILITY OF CONTRACTOR. CONTRACTOR SHALL CALL OREGON 811, CALL BEFORE YOU DIG FOR UNDERGROUND UTILITY LOCATES PRIOR TO CONSTRUCTION ACTIVITIES.
- 4. THE LOCATION, DEPTH, AND SIZE OF EXISTING UTILITIES SHOWN ON THESE PLANS IS APPROXIMATE. THE CONTRACTOR SHALL FIELD VERIFY THE EXISTENCE, LOCATION, DEPTH, SIZE, LINE AND GRADE OF EXISTING UTILITIES CONNECTIONS PRIOR TO CONSTRUCTION. THE CONTRACTOR SHALL BE SOLELY RESPONSIBLE FOR ANY DAMAGE TO THE EXISTING FACILITIES DUE TO FAILURE TO LOCATE OR PROVIDE PROPER PROTECTION WHEN LOCATION IS KNOWN.
- 5. THE CONTRACTOR SHALL MAINTAIN SERVICE OF ALL EXISTING UTILITIES. IF SAID SERVICE IS DAMAGED, THE CONTRACTOR SHALL IMMEDIATELY CONTACT THE UTILITY AND REPAIR THE DAMAGE AT THE CONTRACTORS EXPENSE.
- 6. ALL IMPROVEMENTS ON THIS PROJECT SHALL BE COMPLETED IN ACCORDANCE WITH THE CITY OF SISTERS, OREGON 2020 STANDARD SPECIFICATIONS, AND THE OREGON STANDARD SPECIFICATIONS FOR CONSTRUCTION, 2021.
- 7. TRAFFIC CONTROL PLANS ARE THE RESPONSIBILITY OF THE CONTRACTOR. ALL TRAFFIC CONTROL SHALL BE IN ACCORDANCE WITH THE CITY OF SISTERS, OREGON 2020 STANDARD SPECIFICATIONS AND MANUAL ON UNIFORM TRAFFIC CONTROL DEVICES STANDARDS.
- 8. THE CONTRACTOR SHALL BE RESPONSIBLE FOR OBTAINING ALL APPLICABLE PERMITS REQUIRED FOR CONSTRUCTION AND COMPLYING WITH ALL THE TERMS OF THE PERMITS.
- 9. ANY CHANGES IN PUBLIC RIGHT-OF-WAY SHALL REQUIRE APPROVAL FROM THE CITY OF SISTERS. CONTRACTOR TO ENSURE CITY APPROVAL PROVIDED PRIOR TO CONSTRUCTION.
- 10. ALL QUANTITIES LISTED ARE ESTIMATED QUANTITIES, ACTUAL QUANTITIES MAY VARY. THE CONTRACTOR SHALL BE RESPONSIBLE TO VERIFY ALL QUANTITIES.

CONSTRUCTION NOTES

- 1. CONTRACTOR SHALL VERIFY EXISTING CONDITIONS PRIOR TO CONSTRUCTION. ANY DISCREPANCIES FOUND ARE TO BE BROUGHT TO THE ENGINEERS ATTENTION PRIOR TO COMMENCEMENT OR CONTINUATION OF CONSTRUCTION ACTIVITIES.
- 2. CONTRACTOR SHALL COMPLY WITH ALL APPLICABLE DIVISION OF INDUSTRIAL REGULATIONS (OSHA) SAFETY STANDARDS. IF REQUESTED BY THE INSPECTOR, THE CONTRACTOR SHALL PROVIDE PROOF OF A PERMIT FROM SAID DIVISION.
- 3. THE CONTRACTOR'S OPERATIONS SHALL BE CONFINED WITHIN THE PROJECT LIMITS. MATERIALS AND EQUIPMENT SHALL BE STORED ON THE PROJECT SITE WHERE APPROVED BY THE OWNER. IT SHALL BE UNDERSTOOD THAT THE RESPONSIBILITY FOR PROTECTION AND SAFEKEEPING OF EQUIPMENT AND MATERIALS ON OR NEAR THE SITE WILL BE ENTIRELY THAT OF THE CONTRACTOR AND THAT NO CLAIM SHALL BE MADE AGAINST THE OWNER BY REASON OF ANY ACT OF EMPLOYEE OR TRESPASSER.
- REFERENCE ALL SURVEY MONUMENTS, SECTION CORNERS, 1/4 CORNERS AND PROPERTY CORNERS PRIOR TO BEING DISTURBED BY CONSTRUCTION. ANY MONUMENTS AND CORNERS DISTURBED DURING CONSTRUCTION SHALL BE REPLACED BY A PROFESSIONAL LAND SURVEYOR (PLS) REGISTERED IN THE STATE OF OREGON.
- 5. THE CONTRACTOR SHALL RESTORE ALL ROADWAY SURFACE TO EQUAL, OR BETTER CONDITION THAN EXISTED PRIOR TO EXCAVATION AND CONSTRUCTION, AS DETERMINED BY OWNER AND THE ENGINEER.
- THE CONTRACTOR IS RESPONSIBLE FOR CONTROLLING DUST AND EROSION DURING CONSTRUCTION AT THEIR EXPENSE. STREETS AND DISTURBED AREAS SHALL BE WATERED TO CONTROL DUST WHEN ORDERED BY THE ENGINEER.
- ALL DISTURBED AREAS SHALL BE SEEDED BY THE CONTRACTOR IN ACCORDANCE WITH TECHNICAL SPECIFICATIONS.
- THE CONTRACTOR SHALL BE RESPONSIBLE FOR COORDINATING WITH THE CITY OF SISTERS PUBLIC WORKS DEPARTMENT FOR SHUT DOWN, ABANDONMENT, AND TIE-IN TO EXISTING UTILITIES.
- THE CONTRACTOR SHALL NOTIFY THE CITY OF SISTERS AND ENGINEER 48-HOURS PRIOR TO BEGINNING ANY WORK AND 24 HOURS PRIOR TO ANY SPECIFIC INSPECTION NEEDS DURING THE COURSE OF THE WORK. ALL WORK SHALL BE PERFORMED DURING NORMAL WORKING HOURS AND SUBJECT TO THE AVAILABILITY OF AN INSPECTOR AND APPROVED BY THE ENGINEER.
- 10. A PRE-CONSTRUCTION MEETING SHALL BE HELD WITH CITY OF SISTERS PUBLIC WORKS, CONTRACTOR, SUBCONTRACTOR, AND ENGINEER PRIOR TO THE START OF CONSTRUCTION.
- 11. THE CONTRACTOR SHALL BE RESPONSIBLE FOR PROTECTING ALL PUBLIC AND PRIVATE PROPERTY INSOFAR AS IT MAY BE AFFECTED BY THESE OPERATIONS. ALL COSTS FOR PROTECTING, REMOVING, AND RESTORING EXISTING IMPROVEMENTS SHALL BE BORN SOLELY BY THE CONTRACTOR.
- THE CONTRACTOR SHALL UTILIZE COMPACTION EQUIPMENT SUITABLE FOR THE SOIL TYPES AND SURFACE MATERIALS ENCOUNTERED ON THE PROJECT.
- 13. THE CONTRACTOR IS RESPONSIBLE FOR CREATING, FILING, AND ABIDING BY A STORM WATER POLLUTION PREVENTION PLAN (SWPPP) APPROVED BY THE OREGON DEPARTMENT OF ENVIRONMENTAL QUALITY (DEQ) OR LOCAL GOVERNING AGENCY, AS APPROPRIATE. CONTRACTOR SHALL CONTROL EROSION AND SEDIMENTATION BY INSTALLING SUITABLE BMPS AND MAINTAIN THEM FOR THE DURATION OF THE PROJECT.
- 14. CONTRACTOR IS RESPONSIBLE FOR TRAFFIC CONTROL FOR DURATION OF THE PROJECT.

AB	ANCHOR BOLT	INSTR	INSTRUMENT
ABON ABV	ABANDON ABOVE	INT INVT	INTERIOR INVERT
AC	ASPHALTIC CONCRETE,	JB	JUNCTION BOX
ADDL	ALTERNATING CURRENT ADDITIONAL	JST JT	JOIST JOINT
ADDL ADJ	ADJACENT, ADJUST	L	ANGLE
AHR	ANCHOR	LBS LF	POUNDS LINEAR FEET
ALT ANSI	ALTERNATE AMERICAN NATIONAL	LNTL	LINTEL
	STANDARDS INSTITUTE	LONG LR	LONGITUDINAL LONG RADIUS
APPROX APVD	APPROXIMATE APPROVED	LVL	LEVEL
ASPH	ASPHALT	MATL MAX	MATERIAL MAXIMUM
AVG BD	AVERAGE BOARD	MB	MACHINE BOLT
BETW	BETWEEN	MFD MFR	MANUFACTURED MANUFACTURE, MANUFACTURER
BF BLDG	BOTTOM FACE	MIN	MINIMUM
BLDG BLK	BUILDING BLOCK	MISC MJ	MISCELLANEOUS MECHANICAL JOINT
BLW	BELOW	NIC	NOT IN CONTRACT
BM BOT	BEAM, BENCHMARK BOTTOM	NO NOM	NUMBER NOMINAL
BRG	BEARING	NTS	NOT TO SCALE
BRKT CHAN	BRACKET CHANNEL	OC OD	ON CENTER OUTSIDE DIAMETER
CHK	CHECK	OF	OUTSIDE FACE
CIDO	CAST IRON CIRCULAR	OHP OPNG	OVERHEAD POWER OPNEING
CIRC CJ	CONSTRUCTION JOINT,	PC	POINT OF CURVE
	CONTROL JOINT	PCP PE	PLANT CONTROL VALVE PLAIN END
CL CLG	CENTER LINE CEILING	PEN	PENETRATION
CLR	CLEAR, CLEARANCE	PERP PH	PERPENDICULAR PIPE HANGER
COL COMB	COLUMN COMBINATION	PH PI	PRESSURE INDICATOR, POINT OF
CONC	CONCRETE, CONCENTRIC	PJF	INTERSECTION
COORD	COORDINATE	PL	PREMOLDED JOINT FILLER PLATE, PROPERTY LINE
CORR CP	CORRUGATED CONTROL PANEL	PLYWD	
CPLG	COUPLING	PNL PRCST	PANEL PRECAST
C TO C CTR	CENTER TO CENTER CENTER	PREFAB PRELIM	PREFABRICATED
CU	CUBIC	PROP	PROPERTY
CU FT CU IN	CUBIC FEET CUBIC INCH	PS PT	PRESSURE SWITCH, PIPE SUPPORT POINT, POINT OF TANGENCY
CULV	CULVERT	PVC	POLYVINYL CHLORIDE
CU YD D	CUBIC YARD DRAIN	PVMT RAD	PAVEMENT RADIUS
d	PENNY (NAIL SIZE)	RC	REINFORCED CONCRETE
DBL DET	DOUBLE DETAIL	RD RDCR	· · · · · · · · · · · · · · · · · · ·
DE I	DUCTILE IRON, DRAIN INLET	REBAR	REINFORCEMENT BAR
DIA	DIAMETER	RELOC REQD	RELOCATE, RELOCATION REQUIRED
DIM DIR	DIMENSION DIRECTION	RST	REINFORCING STEEL
DN	DOWN	R/W SCHED	
DR DWG	DOOR DRAWING	SDWK	SIDEWALK
ΞΑ	EACH	SECT SHT	
EL, ELEV ELB	ELEVATION ELBOW	SIM	SIMILAR
ENCL	ENCLOSE	SLP SPEC	
ENGR EP	ENGINEER EDGE OF PAVEMENT	SPG	
EW	EACH WAY	SPRT SQ	SUPPORT SQUARE
EXC	EXCAVATE	SQ FT	
EXP EXP JT	EXPANSION EXPANSION JOINT	SQ IN SST	SQUARE INCH STAINLESS STEEL
EXST	EXISTING	SS	SANITARY SEWER
EXT F	EXTENSION, EXTERIOR FLANGE	STA STD	STATION STANDARD
FAB	FABRICATE	STIF	STIFFENER
FB FC	FLAT BAR FLEXIBLE COUPLING	STL STRUCT	STEEL STRUCTURE
FD	FLOOR DRAIN	SYM	SYMMETRICAL
FDN	FOUNDATION	T&B	TOP AND BOTTOM TOP BACK OF CURB
F. EXT FF	FIRE EXTINGUISHER FINISHED FLOOR	TBC TF	TOP BACK OF CORB
FG 	FINISH GRADE	TEMP	TEMPORARY, TEMPERATURE THROUGH
FL FLEX	FLOOR, FLOW FLEXIBLE	THRU T.O.	TOP OF
FLG	FLANGE	TOC	TOP OF CONCRETE, TOP OF CURB
FLL FIN.	FLOW LINE FINISH	TST TW	TOP OF STEEL TOP OF WALL
FLR	FLOOR	TYP	TYPICAL
FOC FT	FACE OF CONCRETE FOOT, FEET	UBC W	UNIFORM BUILDING CODE WIDTH
FTG	FOOTING, FITTING	WL	WATERLINE
F TO F	FACE TO FACE	WM WS	WIRE MESH, WATER MAIN WATERSTOP, WATER SURFACE
GA GAL	GAGE, GUAGE GALLON	WSTL	WELDED STEEL, WROUGHT STEEL
GALV	GALVANIZED	WT WTR	WEIGHT WATER
GND GSKT	GROUND GASKET	WWF	WELDED WIRE FABRIC
GSP	GALVANIZED STEEL PIPE	WWM YD	WELDED WIRE MESH YARD
GVL	GRAVEL		
ID	INSIDE DIAMETER		

INSTL

1. FOR ABBREVIATIONS NOT LISTED, SEE "ABBREVIATIONS FOR USE ON DRAWINGS AND TEXT", PUBLISHED BY THE AMERICAN NATIONAL STANDARDS INSTITUTE INC. (ANSI) OR CONTACT THE ENGINEER.

INSTALL, INSTALLATION

- 2. THIS IS A STANDARD ABBREVIATION LIST. THEREFORE, NOT ALL ABBREVIATIONS ARE USED ON THE PLANS.
- 3. ADDITIONAL ABBREVIATIONS FOR SPECIALIZED WORK DIVISIONS (INSTRUMENTATION AND CONTROL, ELECTRICAL, ETC.) ARE SHOWN ON OTHER LEGEND



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BIDDERS ARE INSTRUCTED TO CAREFULLY REVIEW THE CONSTRUCTION DOCUMENTS AND THE SITE CONDITIONS SPECIFIC TRADES IS DISPERSED THROUGHOUT THE ENTIRE DOCUMENT SET AND CANNOT BE ACCURATELY DETERMINED BY REFERENCE TO OTHER THAN COMPLETE DOCUMENT SET.

CONSULTANT



PROJECT INFORMATION

BAKER MIXED USE


130 E CASCADE AVENUE SISTERS OREGON 97759

ISSUES

PHASE	100% C
DATE	AUGUST 4, 202
JOB NUMBER	21-053-OF

SHEET NAME

GENERAL NOTES

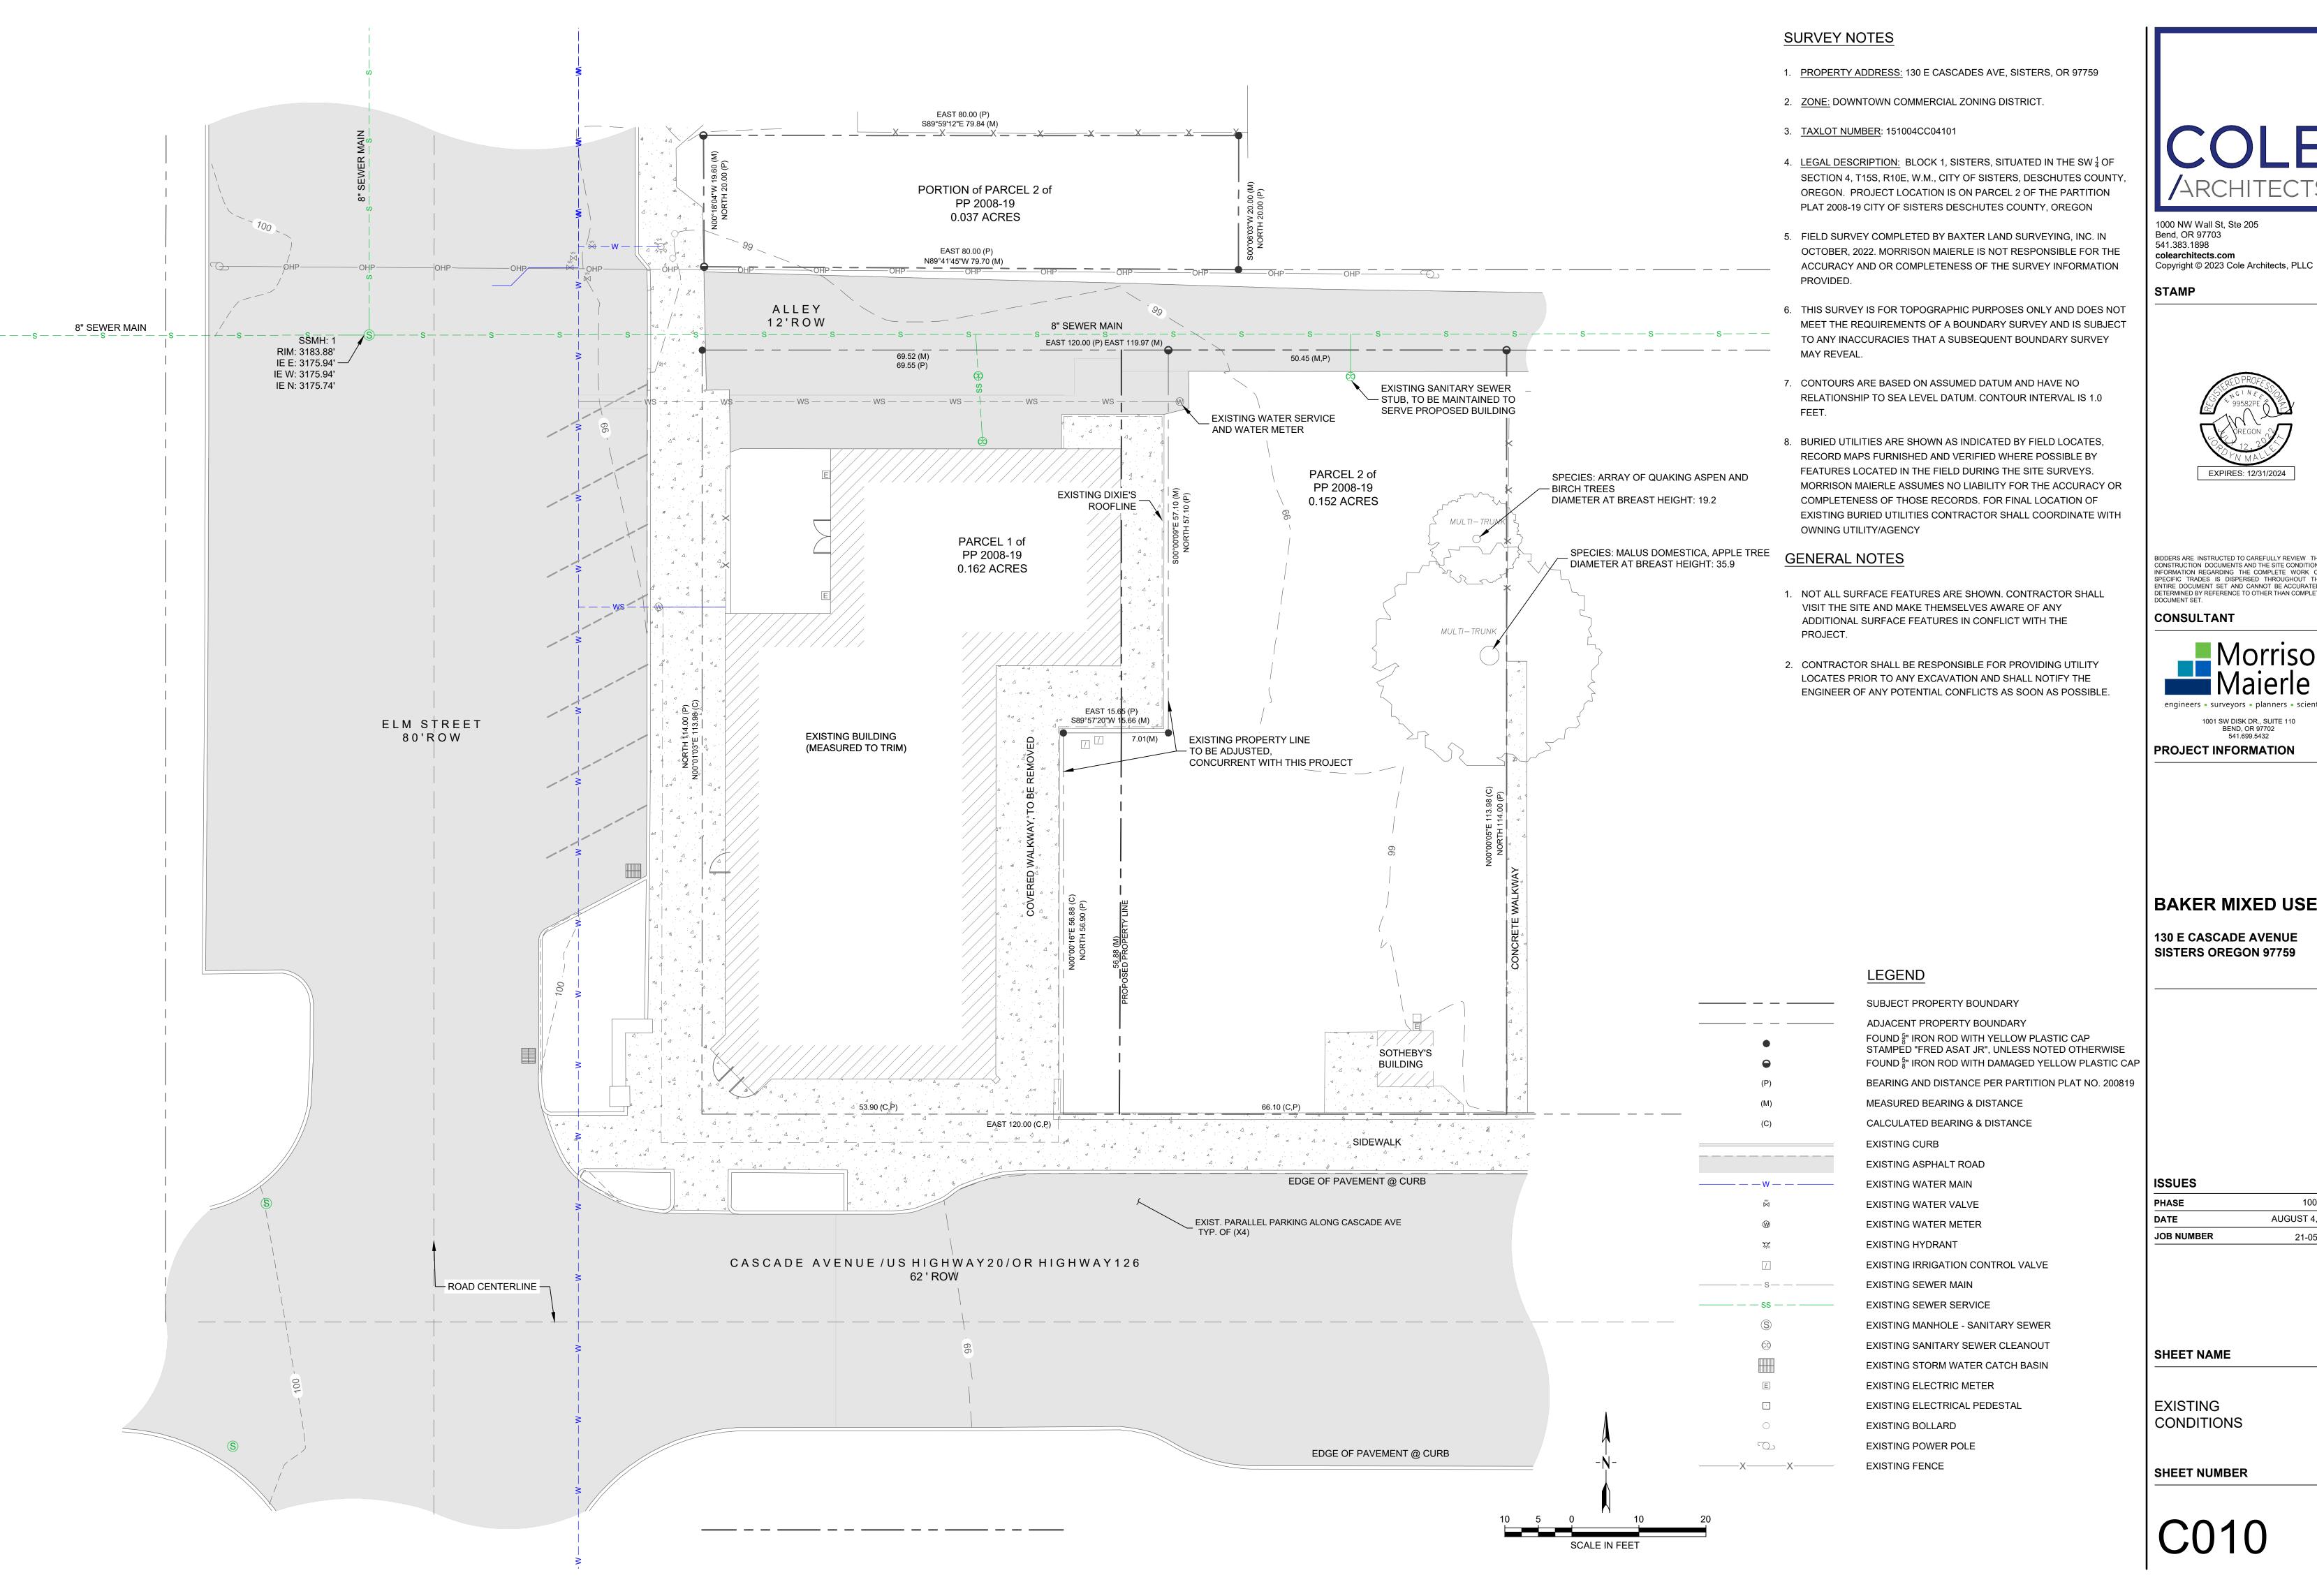



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PROJECT INFORMATION


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130 E CASCADE AVENUE SISTERS OREGON 97759

IASE	100% CD
TE	AUGUST 4, 2023
B NUMBER	21-053-OR

SHEET NAME

EXISTING CONDITIONS

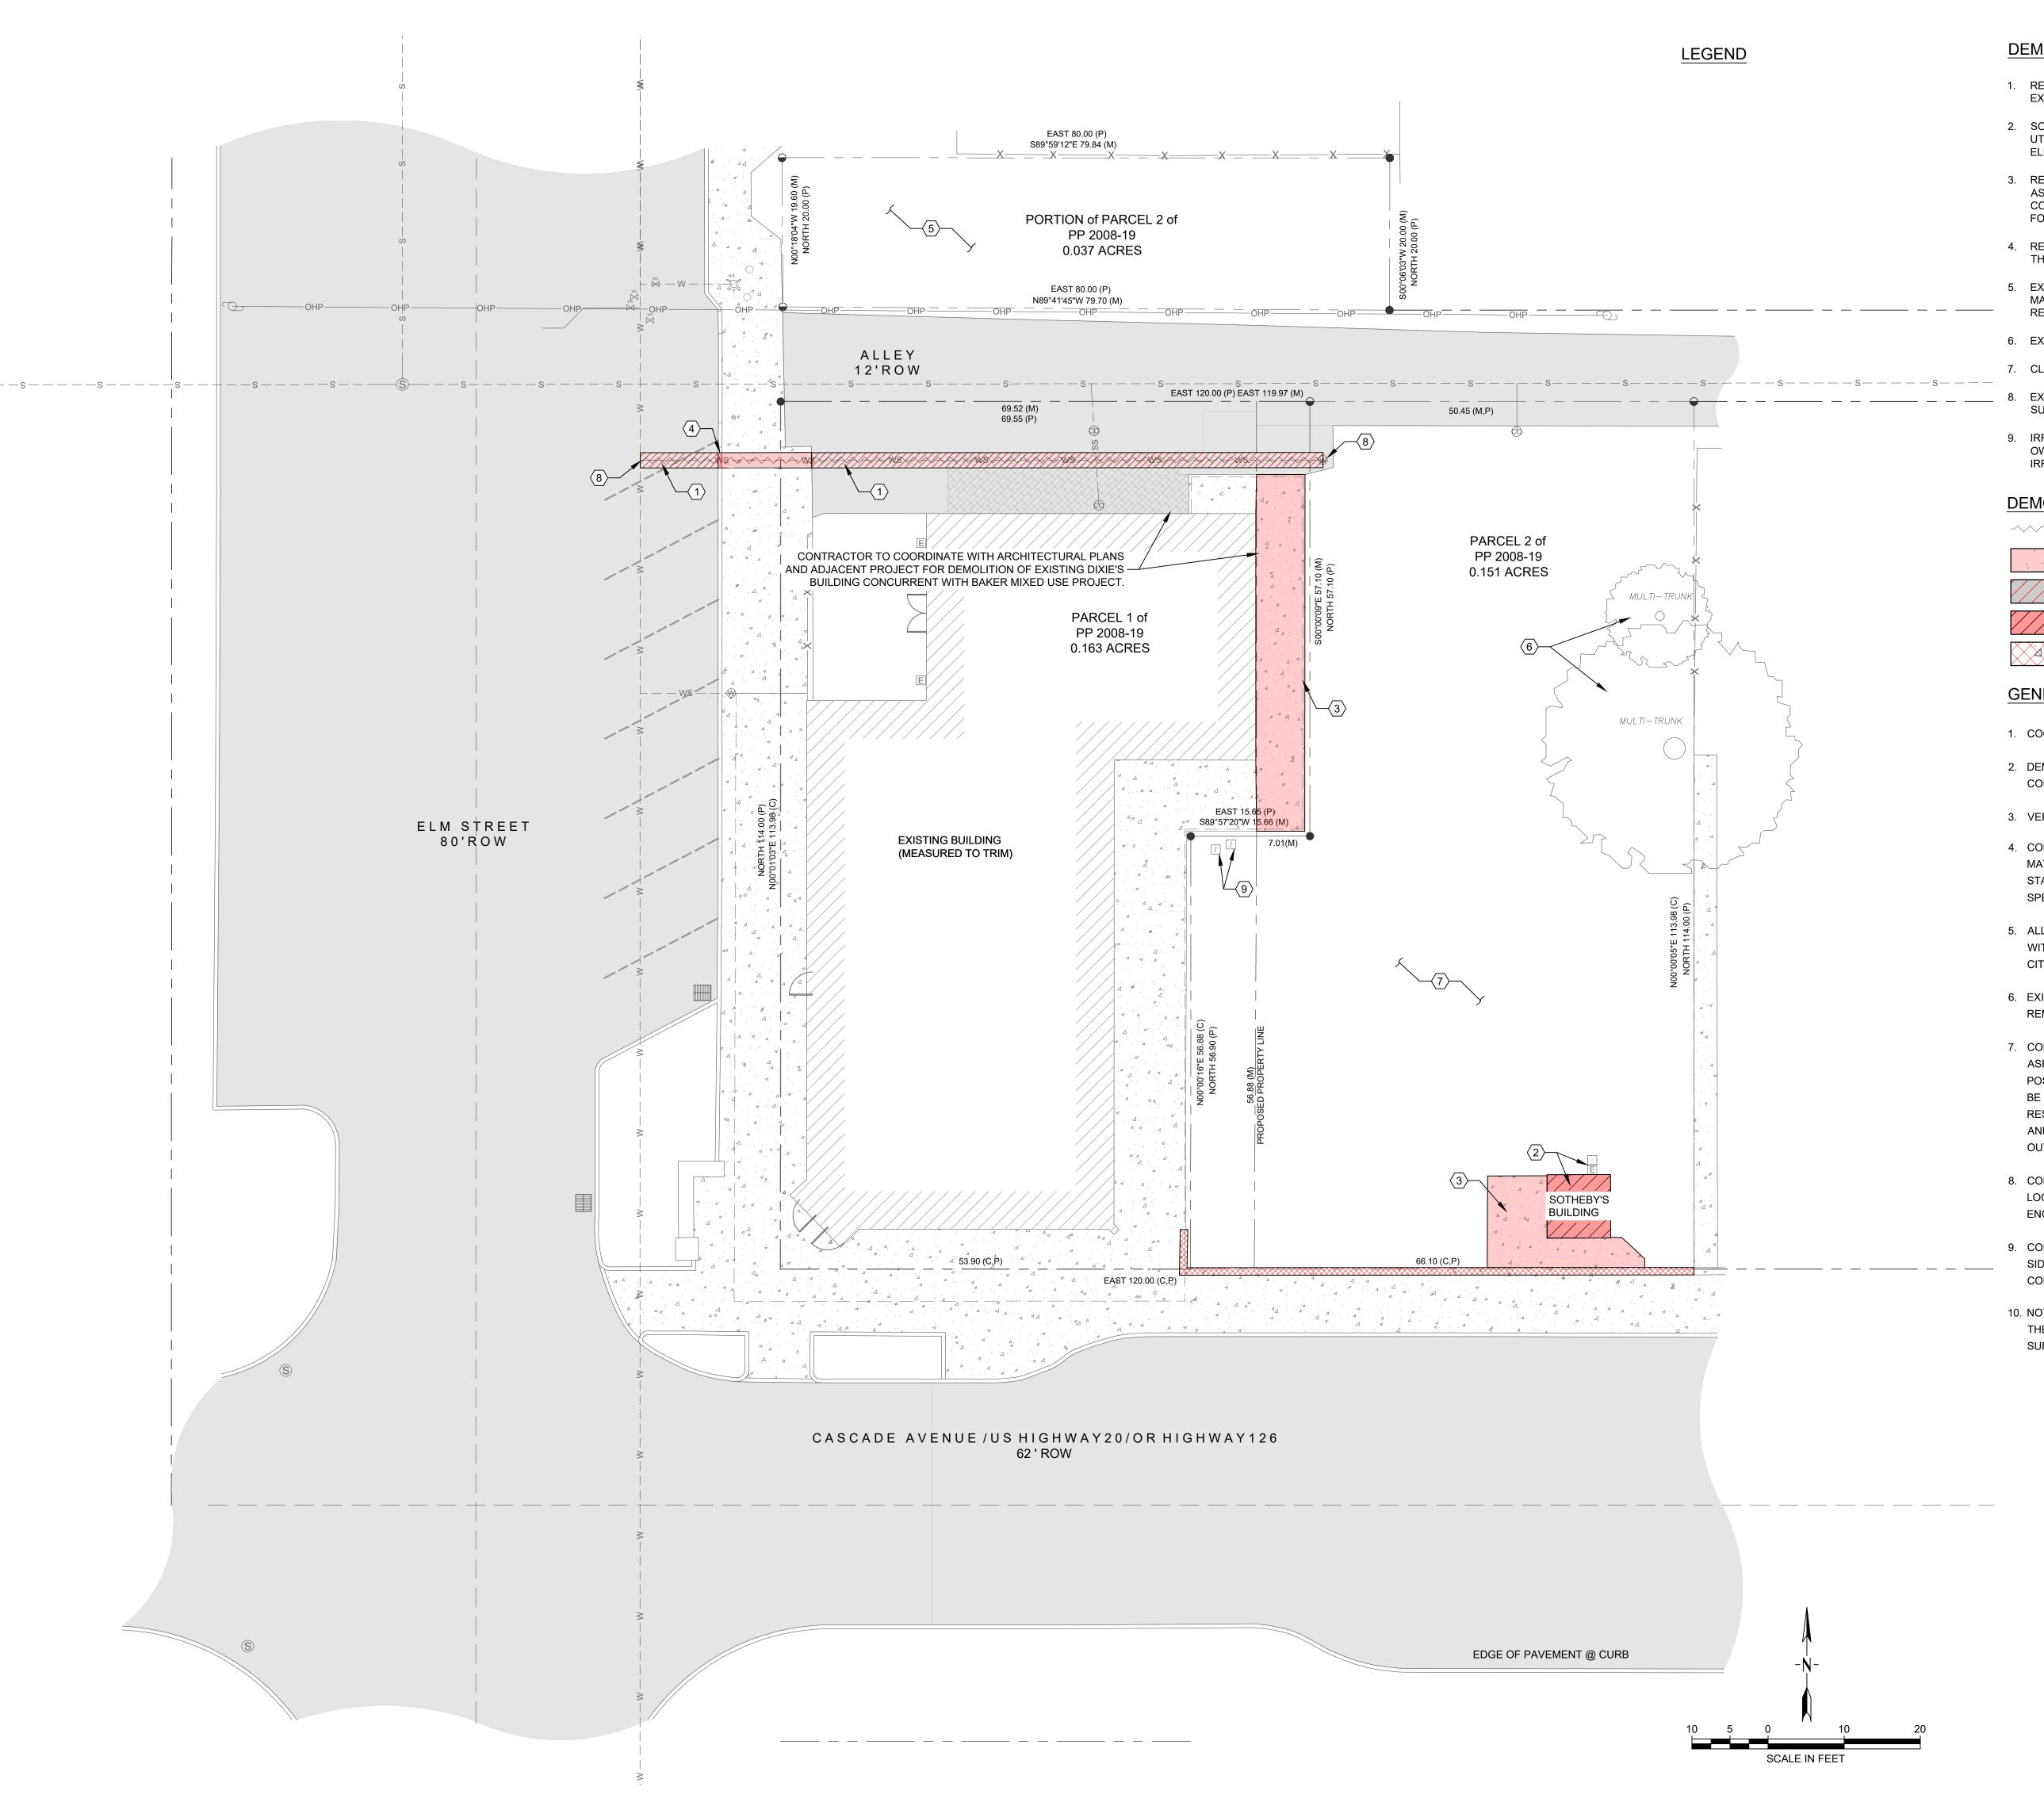


DEMOLITION KEY NOTES (#)

- 1. REMOVE AND PROPERLY DISPOSE OF EXISTING ASPHALT TO THE EXTENTS SHOWN.
- 2. SOTHEBY'S BUILDING AND ASSOCIATED SITE IMPROVEMENTS AND UTILITIES TO BE REMOVED. COORDINATE REMOVAL WITH CENTRAL ELECTRIC CO-OP. CONTACT NUMBER: (541) 389-1980.
- 3. REMOVE AND PROPERLY DISPOSE OF EXISTING CONCRETE AND ASSOCIATED BUILDING MATERIALS TO THE EXTENTS SHOWN. COORDINATE WITH ARCHITECTURAL SHEETS AND DEMOLITION PLANS FOR ADJACENT BUILDING. SAWCUT TO NEAREST JOINT
- 4. REMOVE AND PROPERLY DISPOSE OF EXISTING CURB & GUTTER TO THE EXTENTS SHOWN
- 5. EXISTING GRAVEL TO BE REMOVED; MAY BE REUSED ON SITE IF MATERIAL MEETS PROJECT SPECIFICATIONS AND GEOTECHNICAL REQUIREMENTS
- 6. EXISTING TREES TO BE REMOVED, TYP. (X2)
- 7. CLEAR AND GRUB EXISTING VEGETATED AREA
- 8. EXISTING WATER SERVICE AND ASSOCIATED APPURTENANCES TO SUBJECT SITE TO BE ABANDONED AT THE MAIN
- 9. IRRIGATION CONTROL BOXES TO BE RELOCATED, COORDINATE WITH OWNER. CONTRACTOR TO ENSURE FUNCTIONALITY OF EXISTING IRRIGATION SYSTEMS TO REMAIN.

DEMOLITION LEGEND

SITE IMPROVEMENT REMOVAL

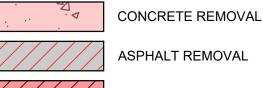

BUILDING REMOVAL

CURB AND GUTTER REMOVAL

GENERAL NOTES

- 1. COORDINATE DEMOLITION WORK WITH SCOPE OF ADJACENT PROJECT
- DEMOLITION SHALL NOT PROCEED UNTIL EROSION & SEDIMENTATION CONTROL MEASURES HAVE BEEN INSTALLED.
- 3. VERIFY EXTENTS OF DEMOLITION PRIOR TO BIDDING
- 4. CONTRACTOR IS RESPONSIBLE FOR REMOVAL AND DISPOSAL OF ALL MATERIALS IN ACCORDANCE WITH CITY OF SISTERS PUBLIC WORKS STANDARDS AND SPECIFICATIONS, AND OREGON STANDARD SPECIFICATIONS FOR CONSTRUCTION 2020.
- 5. ALL DISTURBANCE OF EXISTING UTILITIES SHALL BE COORDINATED WITH OWNING UTILITY COMPANY PRIOR TO DISTURBANCE INCLUDING CITY OF SISTERS.
- 6. EXISTING CONCRETE SECTION AND CONCRETE CURB & GUTTER REMOVAL SHALL BE NEATLINE SAWCUT TO THE NEAREST JOINT.
- 7. CONTRACTOR SHALL TAKE CARE TO PRESERVE & PROTECT EXISTING ASPHALT TO REMAIN ADJACENT TO THE SITE TO MAXIMUM EXTENT POSSIBLE. ANY DAMAGE DEEMED UNNECESSARY BY ENGINEER SHALL BE REPAIRED AT CONTRACTOR EXPENSE. CONTRACTOR SHALL BE RESPONSIBLE FOR REPAIRS TO CONCRETE SIDEWALK, CURB & GUTTER AND ASPHALT THAT IS DAMAGED DURING CONSTRUCTION NOT CALLED OUT FOR REMOVAL.
- 8. CONTRACTOR SHALL BE RESPONSIBLE FOR PROVIDING UTILITY LOCATES PRIOR TO ANY EXCAVATION AND SHALL NOTIFY THE ENGINEER OF ANY POTENTIAL CONFLICTS AS SOON AS POSSIBLE
- 9. CONTRACTOR SHALL BE RESPONSIBLE FOR REPAIRS TO CONCRETE SIDEWALK, CURB & GUTTER AND ASPHALT THAT IS DAMAGED DURING CONSTRUCTION NOT CALLED OUT FOR REMOVAL.
- 10. NOT ALL SURFACE FEATURES ARE SHOWN. CONTRACTOR SHALL VISIT THE SITE AND MAKE THEMSELVES AWARE OF ANY ADDITIONAL SURFACE FEATURES IN CONFLICT WITH THE PROJECT.



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PROJECT INFORMATION

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130 E CASCADE AVENUE SISTERS OREGON 97759

ISSUES


PHASE	100% CI	
DATE	AUGUST 4, 2023	
JOB NUMBER	21-053-OR	

SHEET NAME

DEMOLITION PLAN

SHEET NUMBER

C020

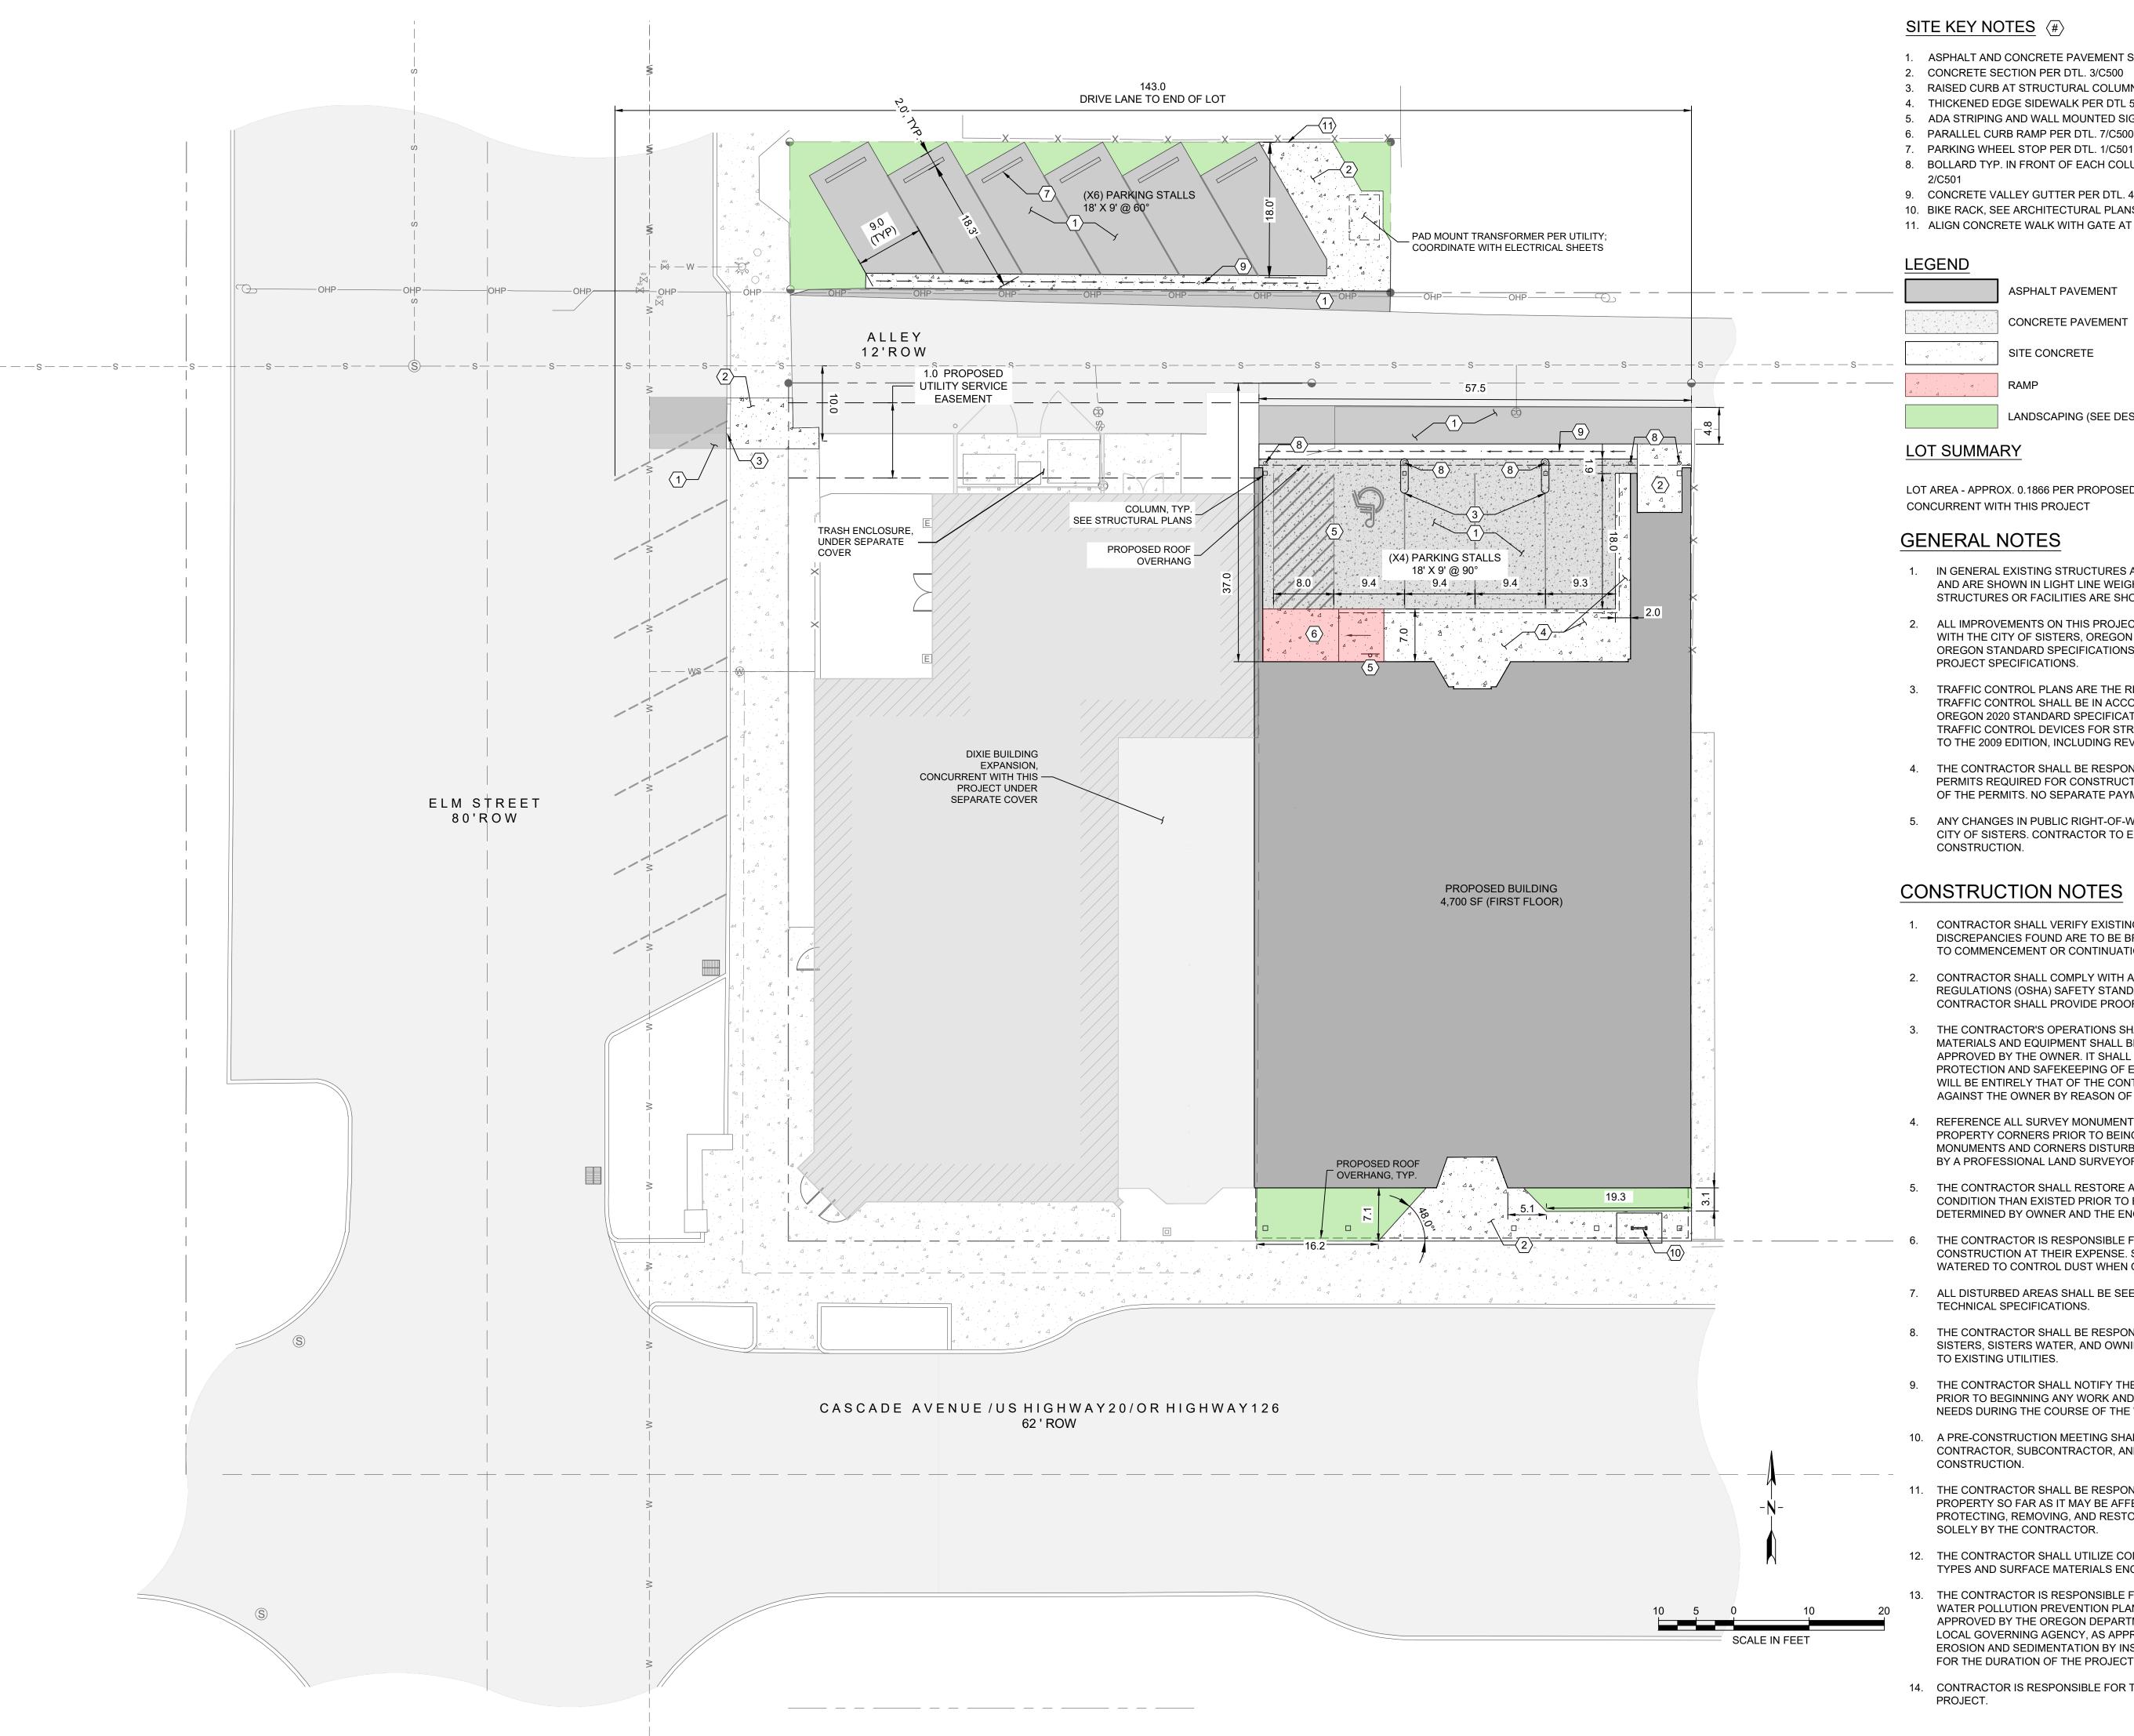

SITE KEY NOTES (#)

- 1. ASPHALT AND CONCRETE PAVEMENT SECTIONS PER DTL. 2/C500
- 2. CONCRETE SECTION PER DTL. 3/C500
- 3. RAISED CURB AT STRUCTURAL COLUMN, SEE ARCHITECTURAL PLANS FOR DETAIL.
- 4. THICKENED EDGE SIDEWALK PER DTL 5/C500
- 5. ADA STRIPING AND WALL MOUNTED SIGNAGE PER DTL. 6/C500
- 6. PARALLEL CURB RAMP PER DTL. 7/C500
- 8. BOLLARD TYP. IN FRONT OF EACH COLUMN AT NORTH END OF BUILDING PER DTL
- 9. CONCRETE VALLEY GUTTER PER DTL. 4/C502
- 10. BIKE RACK, SEE ARCHITECTURAL PLANS FOR DETAIL.
- 11. ALIGN CONCRETE WALK WITH GATE AT NEIGHBORING PROPERTY



LANDSCAPING (SEE DESIGN-BUILD LANDSCAPING PLANS)

LOT SUMMARY


LOT AREA - APPROX. 0.1866 PER PROPOSED LOT LINE ADJUSTMENT CONCURRENT WITH THIS PROJECT

GENERAL NOTES

- 1. IN GENERAL EXISTING STRUCTURES AND FACILITIES ARE NOTED AS "EXISTING" AND ARE SHOWN IN LIGHT LINE WEIGHTS OR AS SCREENED BACKGROUND. NEW STRUCTURES OR FACILITIES ARE SHOWN IN HEAVY LINE WEIGHTS.
- 2. ALL IMPROVEMENTS ON THIS PROJECT SHALL BE COMPLETED IN ACCORDANCE WITH THE CITY OF SISTERS, OREGON 2020 STANDARD SPECIFICATIONS AND THE OREGON STANDARD SPECIFICATIONS FOR CONSTRUCTION, 2021, AND THE PROJECT SPECIFICATIONS.
- TRAFFIC CONTROL PLANS ARE THE RESPONSIBILITY OF THE CONTRACTOR. ALL TRAFFIC CONTROL SHALL BE IN ACCORDANCE WITH THE CITY OF SISTERS, OREGON 2020 STANDARD SPECIFICATIONS AND THE MANUAL ON UNIFORM TRAFFIC CONTROL DEVICES FOR STREETS AND HIGHWAYS OREGON SUPPLEMENT TO THE 2009 EDITION, INCLUDING REVISION 1 DATES DECEMBER 2020.
- 4. THE CONTRACTOR SHALL BE RESPONSIBLE FOR OBTAINING ALL APPLICABLE PERMITS REQUIRED FOR CONSTRUCTION AND COMPLYING WITH ALL THE TERMS OF THE PERMITS. NO SEPARATE PAYMENT WILL BE MADE FOR THIS WORK.
- ANY CHANGES IN PUBLIC RIGHT-OF-WAY SHALL REQUIRE APPROVAL FROM THE CITY OF SISTERS. CONTRACTOR TO ENSURE CITY APPROVAL PROVIDED PRIOR TO CONSTRUCTION.

CONSTRUCTION NOTES

- CONTRACTOR SHALL VERIFY EXISTING CONDITIONS PRIOR TO CONSTRUCTION. ANY DISCREPANCIES FOUND ARE TO BE BROUGHT TO THE ENGINEERS ATTENTION PRIOR TO COMMENCEMENT OR CONTINUATION OF CONSTRUCTION ACTIVITIES.
- 2. CONTRACTOR SHALL COMPLY WITH ALL APPLICABLE DIVISION OF INDUSTRIAL REGULATIONS (OSHA) SAFETY STANDARDS. IF REQUESTED BY THE INSPECTOR, THE CONTRACTOR SHALL PROVIDE PROOF OF A PERMIT FROM SAID DIVISION.
- THE CONTRACTOR'S OPERATIONS SHALL BE CONFINED WITHIN THE PROJECT LIMITS. MATERIALS AND EQUIPMENT SHALL BE STORED ON THE PROJECT SITE WHERE APPROVED BY THE OWNER. IT SHALL BE UNDERSTOOD THAT THE RESPONSIBILITY FOR PROTECTION AND SAFEKEEPING OF EQUIPMENT AND MATERIALS ON OR NEAR THE SITE WILL BE ENTIRELY THAT OF THE CONTRACTOR AND THAT NO CLAIM SHALL BE MADE AGAINST THE OWNER BY REASON OF ANY ACT OF EMPLOYEE OR TRESPASSER.
- 4. REFERENCE ALL SURVEY MONUMENTS, SECTION CORNERS, 1/4 CORNERS AND PROPERTY CORNERS PRIOR TO BEING DISTURBED BY CONSTRUCTION. ANY MONUMENTS AND CORNERS DISTURBED DURING CONSTRUCTION SHALL BE REPLACED BY A PROFESSIONAL LAND SURVEYOR (PLS) REGISTERED IN THE STATE OF OREGON.
- 5. THE CONTRACTOR SHALL RESTORE ALL ROADWAY SURFACE TO EQUAL, OR BETTER CONDITION THAN EXISTED PRIOR TO EXCAVATION AND CONSTRUCTION, AS DETERMINED BY OWNER AND THE ENGINEER.
- THE CONTRACTOR IS RESPONSIBLE FOR CONTROLLING DUST AND EROSION DURING CONSTRUCTION AT THEIR EXPENSE. STREETS AND DISTURBED AREAS SHALL BE WATERED TO CONTROL DUST WHEN ORDERED BY THE ENGINEER.
- 7. ALL DISTURBED AREAS SHALL BE SEEDED BY THE CONTRACTOR IN ACCORDANCE WITH TECHNICAL SPECIFICATIONS.
- 8. THE CONTRACTOR SHALL BE RESPONSIBLE FOR COORDINATING WITH CITY OF SISTERS, SISTERS WATER, AND OWNING UTILITY COMPANY FOR SHUT DOWN AND TIE-IN TO EXISTING UTILITIES.
- 9. THE CONTRACTOR SHALL NOTIFY THE CITY OF SISTERS AND ENGINEER 48-HOURS PRIOR TO BEGINNING ANY WORK AND 24 HOURS PRIOR TO ANY SPECIFIC INSPECTION NEEDS DURING THE COURSE OF THE WORK.
- 10. A PRE-CONSTRUCTION MEETING SHALL BE HELD WITH CITY OF SISTERS, OWNER, CONTRACTOR, SUBCONTRACTOR, AND ENGINEER PRIOR TO THE START OF
- 11. THE CONTRACTOR SHALL BE RESPONSIBLE FOR PROTECTING ALL PUBLIC AND PRIVATE PROPERTY SO FAR AS IT MAY BE AFFECTED BY THESE OPERATIONS. ALL COSTS FOR PROTECTING, REMOVING, AND RESTORING EXISTING IMPROVEMENTS SHALL BE BORN SOLELY BY THE CONTRACTOR.
- 12. THE CONTRACTOR SHALL UTILIZE COMPACTION EQUIPMENT SUITABLE FOR THE SOIL TYPES AND SURFACE MATERIALS ENCOUNTERED ON THE PROJECT.
- 13. THE CONTRACTOR IS RESPONSIBLE FOR CREATING, FILING, AND ABIDING BY A STORM WATER POLLUTION PREVENTION PLAN (SWPPP) AND NOTICE OF INTENT (NOI) APPROVED BY THE OREGON DEPARTMENT OF ENVIRONMENTAL QUALITY (ODEQ) OR LOCAL GOVERNING AGENCY, AS APPROPRIATE. CONTRACTOR SHALL CONTROL EROSION AND SEDIMENTATION BY INSTALLING SUITABLE BMPS AND MAINTAIN THEM FOR THE DURATION OF THE PROJECT.
- 14. CONTRACTOR IS RESPONSIBLE FOR TRAFFIC CONTROL FOR DURATION OF THE

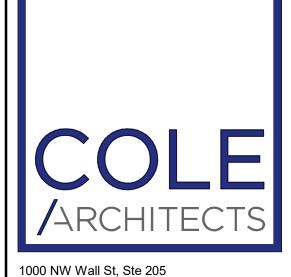

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CONSTRUCTION DOCUMENTS AND THE SITE CONDITIONS INFORMATION REGARDING THE COMPLETE WORK OF SPECIFIC TRADES IS DISPERSED THROUGHOUT THE DETERMINED BY REFERENCE TO OTHER THAN COMPLETE DOCUMENT SET.

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PROJECT INFORMATION

BAKER MIXED USE


130 E CASCADE AVENUE SISTERS OREGON 97759

ISSUES

PHASE 100% CD DATE AUGUST 4, 2023 **JOB NUMBER** 21-053-OR

SHEET NAME

SITE PLAN

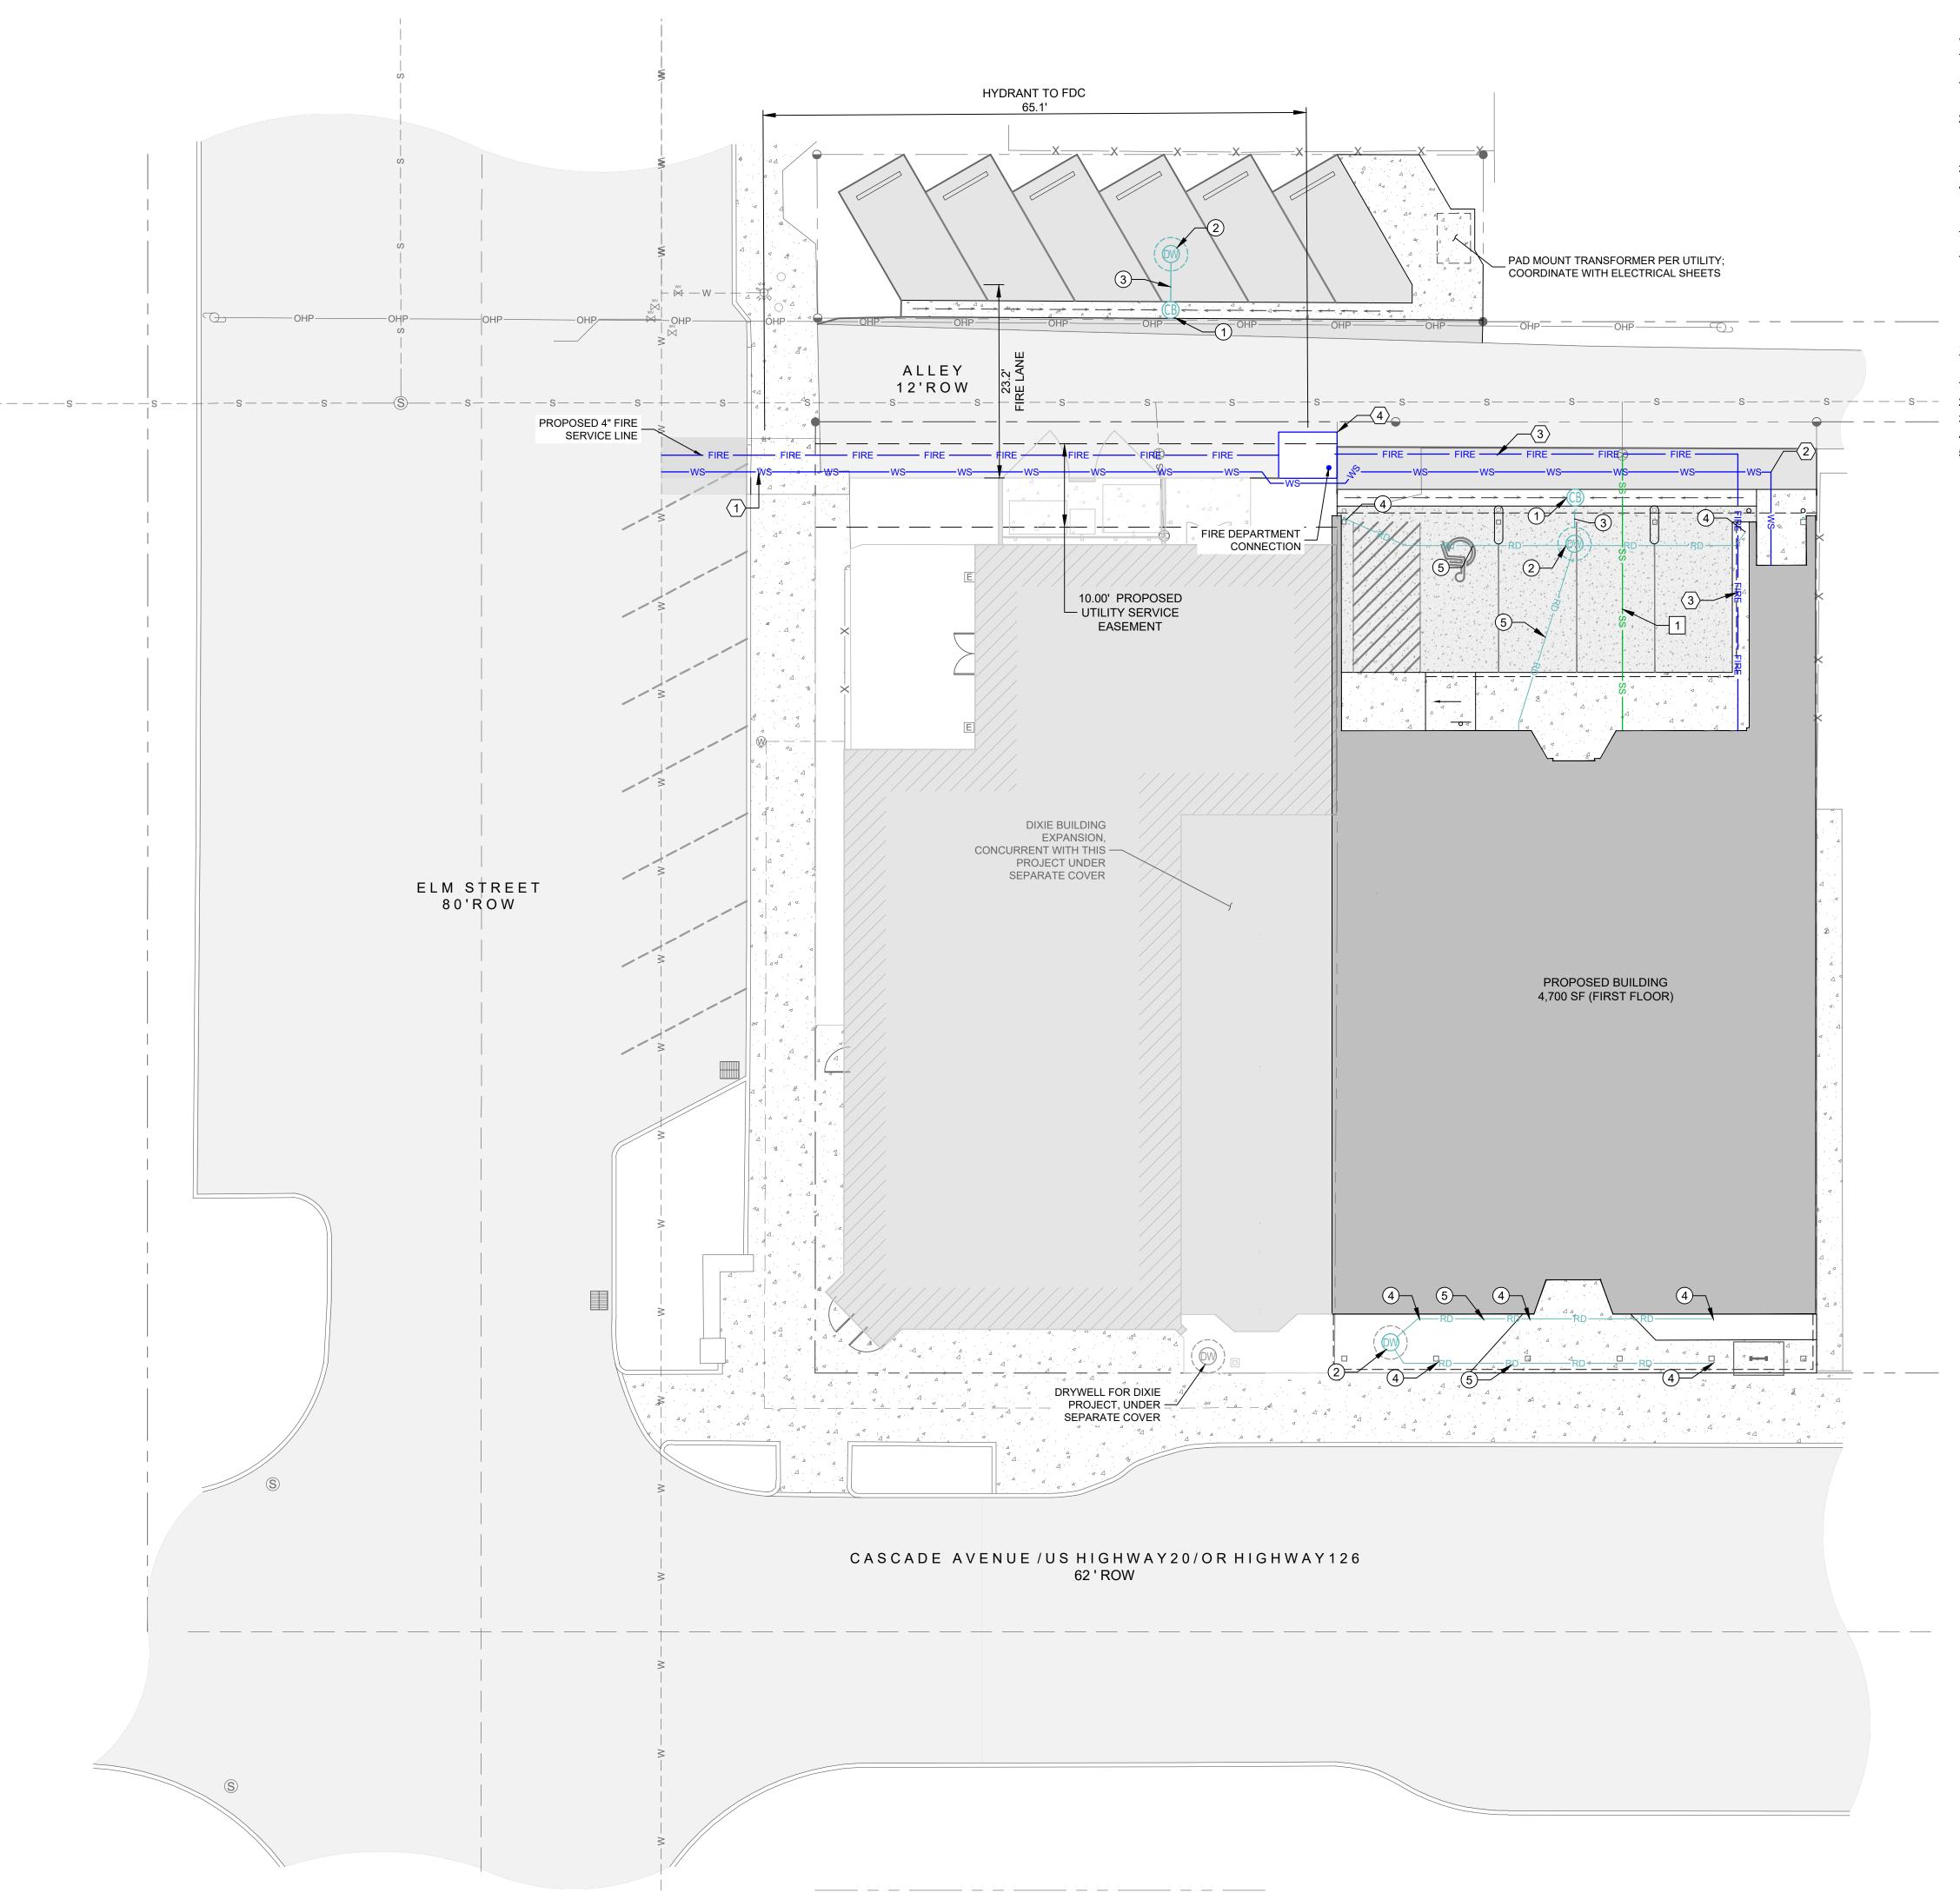

WATER KEY NOTES (#)

- 1. 2" DOMESTIC WATER SERVICE AND 2" METER PIT PER DTL. 3/C501
- 2. 90° ELBOW BUILDING WATER SERVICE CONNECTION. COORDINATE BUILDING ENTRANCE 3.
- WITH PLUMBING PLANS.
- 3. 4" DIAMETER FIRE WATER SERVICE
- 4. 4" FDC PER DTL. 4/C501

SANITARY SEWER KEY NOTES

1. 31 LF 4" SDR 35 GRAVITY SEWER SERVICE AT S=2% MIN. PER DTL. 5/C501, CONNECT TO EXISTING SERVICE STUB; COORDINATE BUILDING CONNECTION WITH PLUMBING PLANS.

STORM SEWER KEY NOTES (#)

- 1. SEDIMENTATION MANHOLE PER DTL. 1/C502
- 2. DRYWELL PER DTL. 2/C502
- 3. 10" SDR 35 PVC STORM DRAIN PIPING @ S=1% MIN. 4. DOWNSPOUT CONNECTION PER DTL. 3/C502
- 5. 6" BUILDING ROOF DRAIN PIPING @ S=1% MIN. COORDINATE WITH PLUMBING PLANS

WATER NOTES

1. DIMENSIONS SHOWN ARE TO CENTERLINE OF PIPE OR FITTINGS UNLESS OTHERWISE NOTED.

RESPECT TO FINISHED GRADE.

- 2. WATER PIPE SHALL HAVE MINIMUM COVER OF 36" WITH
- SIZE AND TYPE OF FITTINGS AND JOINT MATERIALS ON DRAWINGS SHALL CORRESPOND TO ADJACENT
- STRAIGHT RUN OF PIPE, UNLESS OTHERWISE INDICATED 4. ALL FLEXIBLE CONNECTORS OR FLANGED COUPLING ADAPTERS SHALL BE PROVIDED WITH THRUST TIES, BLOCKS, OR ANCHORS, UNLESS OTHERWISE NOTED. THRUST PROTECTION SHALL BE ADEQUATE FOR TEST
- PRESSURES SPECIFIED. THRUST BLOCKS ARE NOT GENERALLY SHOWN ON THE DRAWINGS. BENDS EQUAL TO OR GREATER THAN TWENTY-TWO AND ONE-HALF DEGREES (22.5°), TEEES, AND PLUGS ON ALL BURIED PIPING SPECIFIED TO BE PRESSURE TESTED, SHALL BE PROVIDED WITH THRUST
- PROTECTION, UNLESS OTHERWISE NOTED. ALL WATER MAIN AND WATER SERVICE LINES SHALL BE
- INSTALLED IN ACCORDANCE WITH OREGON STANDARD SPECIFICATIONS FOR CONSTRUCTION, 2021 AND CITY OF REDMOND PUBLIC WORKS STANDARDS & SPECIFICATIONS AND SPECIAL PROVISIONS, JULY 2022
- CONTRACTOR SHALL BE RESPONSIBLE FOR ALL TAP AND TIE IN FEES REQUIRED.
- 8. ALL PUBLIC WATER VALVES SHALL ONLY BE OPERATED
- BY CITY STAFF. 9. LAY WATER SERVICE TO WITHIN 5 FEET OF BUILDING. WATER CONNECTIONS TO INTERNAL BUILDING PLUMBING
- SHALL BE PERFORMED BY LICENSED PLUMBER. 10. ALL PROVISIONS FOR COMPLETING THE WATER SYSTEM ACCEPTANCE TESTING IN ACCORDANCE WITH PROJECT SPECIFICATIONS SHALL BE THE RESPONSIBILITY OF THE CONTRACTOR AND CONSIDERED INCIDENTAL TO OTHER PAY ITEMS.
- 11. CONTRACTOR SHALL VERIFY DEPTH AND LOCATION OF ALL EXISTING UTILITY LINES AHEAD OF NEW UNDERGROUND UTILITY INSTALL.

SANITARY SEWER NOTES

- 1. DIMENSIONS SHOWN ARE TO CENTERLINE OF PIPE OR FITTINGS UNLESS OTHERWISE NOTED.
- 2. LAY PIPE TO UNIFORM GRADE BETWEEN INDICATED ELEVATIONS. 3. SANITARY SEWER PIPE SHALL HAVE MINIMUM COVER OF
- 36" WITH RESPECT TO FINISHED GRADE. 4. CONTRACTOR SHALL BE RESPONSIBLE FOR ALL TAP AND
- TIE IN FEES REQUIRED. 5. LAY SEWER SERVICE TO WITHIN 5 FEET OF BUILDING.
- SEWER CONNECTIONS TO INTERNAL BUILDING PLUMBING SHALL BE PERFORMED BY LICENSED PLUMBER. 6. CLEANOUTS SHALL BE INSTALLED WITHIN 3' OF BUILDING,
- EVERY 100', AND AT DIRECTION CHANGES OF 45° OR GREATER.

DRAINAGE NOTES

- 1. DIMENSIONS SHOWN ARE TO CENTERLINE OF PIPE OR FITTINGS UNLESS OTHERWISE NOTED.
- 2. ALL STORM DRAIN PIPE SHALL BE SDR 35 PVC UNLESS OTHERWISE NOTED.
- 3. STORM DRAIN PIPE SHALL HAVE MINIMUM COVER OF 12" WITH RESPECT TO FINISHED GRADE.
- 4. CONTRACTOR SHALL COORDINATE UTILITY INSTALLATIONS TO AVOID CONFLICTS WITH ALL OTHER EXISTING AND PROPOSED UTILITIES.

SCALE IN FEET



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PROJECT INFORMATION

BAKER MIXED USE


130 E CASCADE AVENUE SISTERS OREGON 97759

ISSUES

PHASE 100% CD DATE AUGUST 4, 2023 **JOB NUMBER** 21-053-OR


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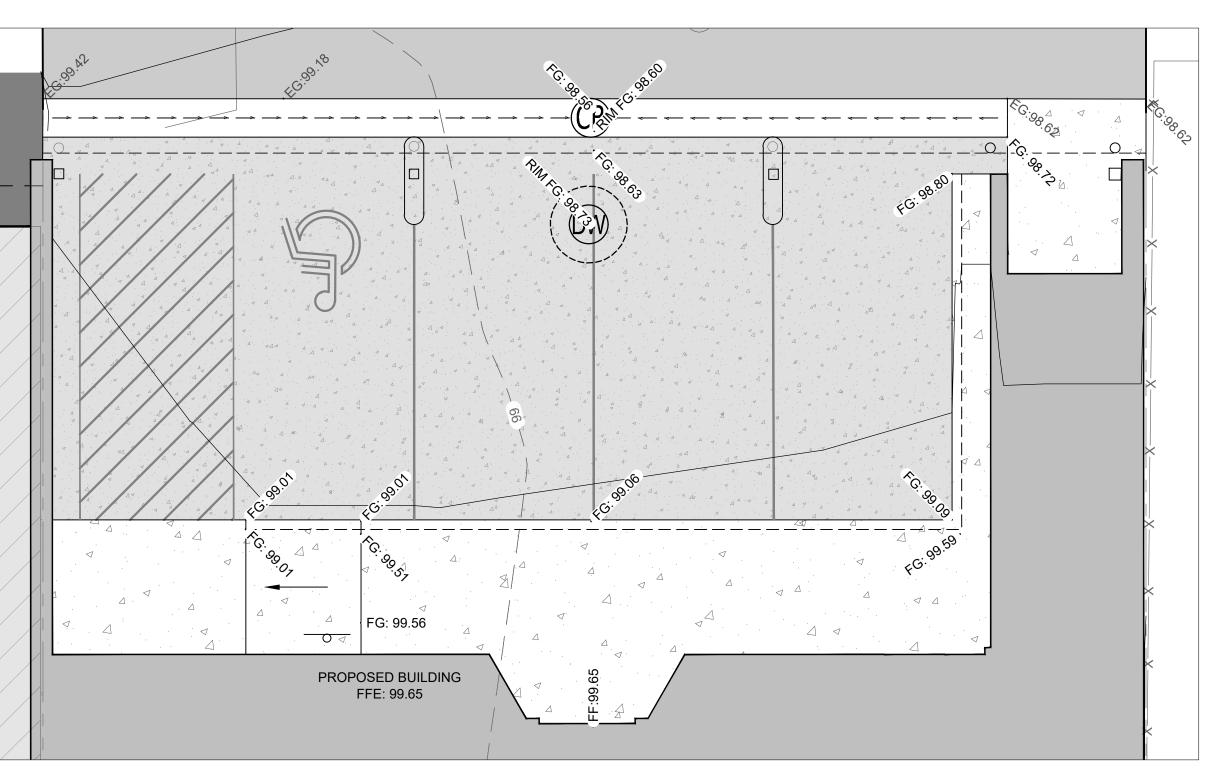
UTILITY PLAN

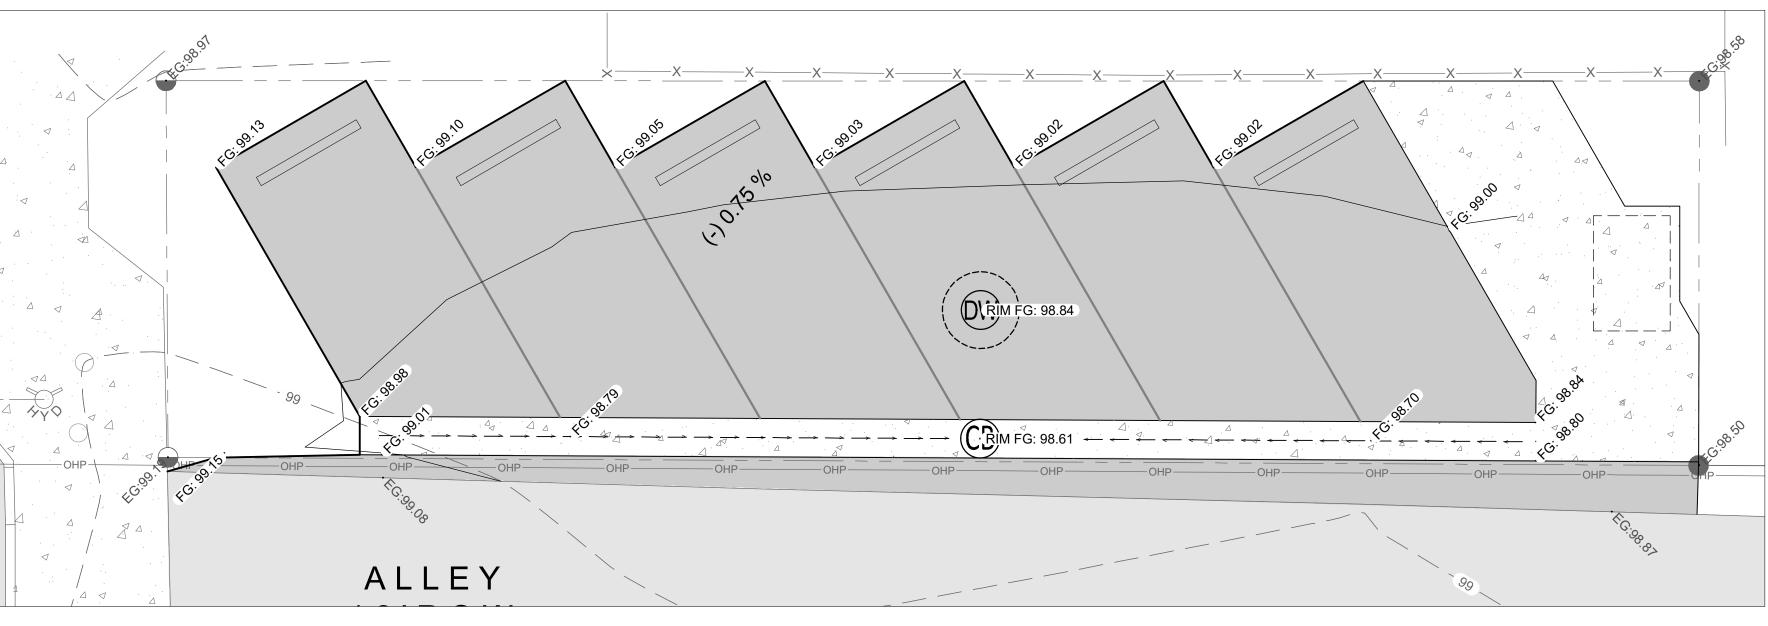


NORTH PARKING - DETAIL

SCALE: 1" = 5'



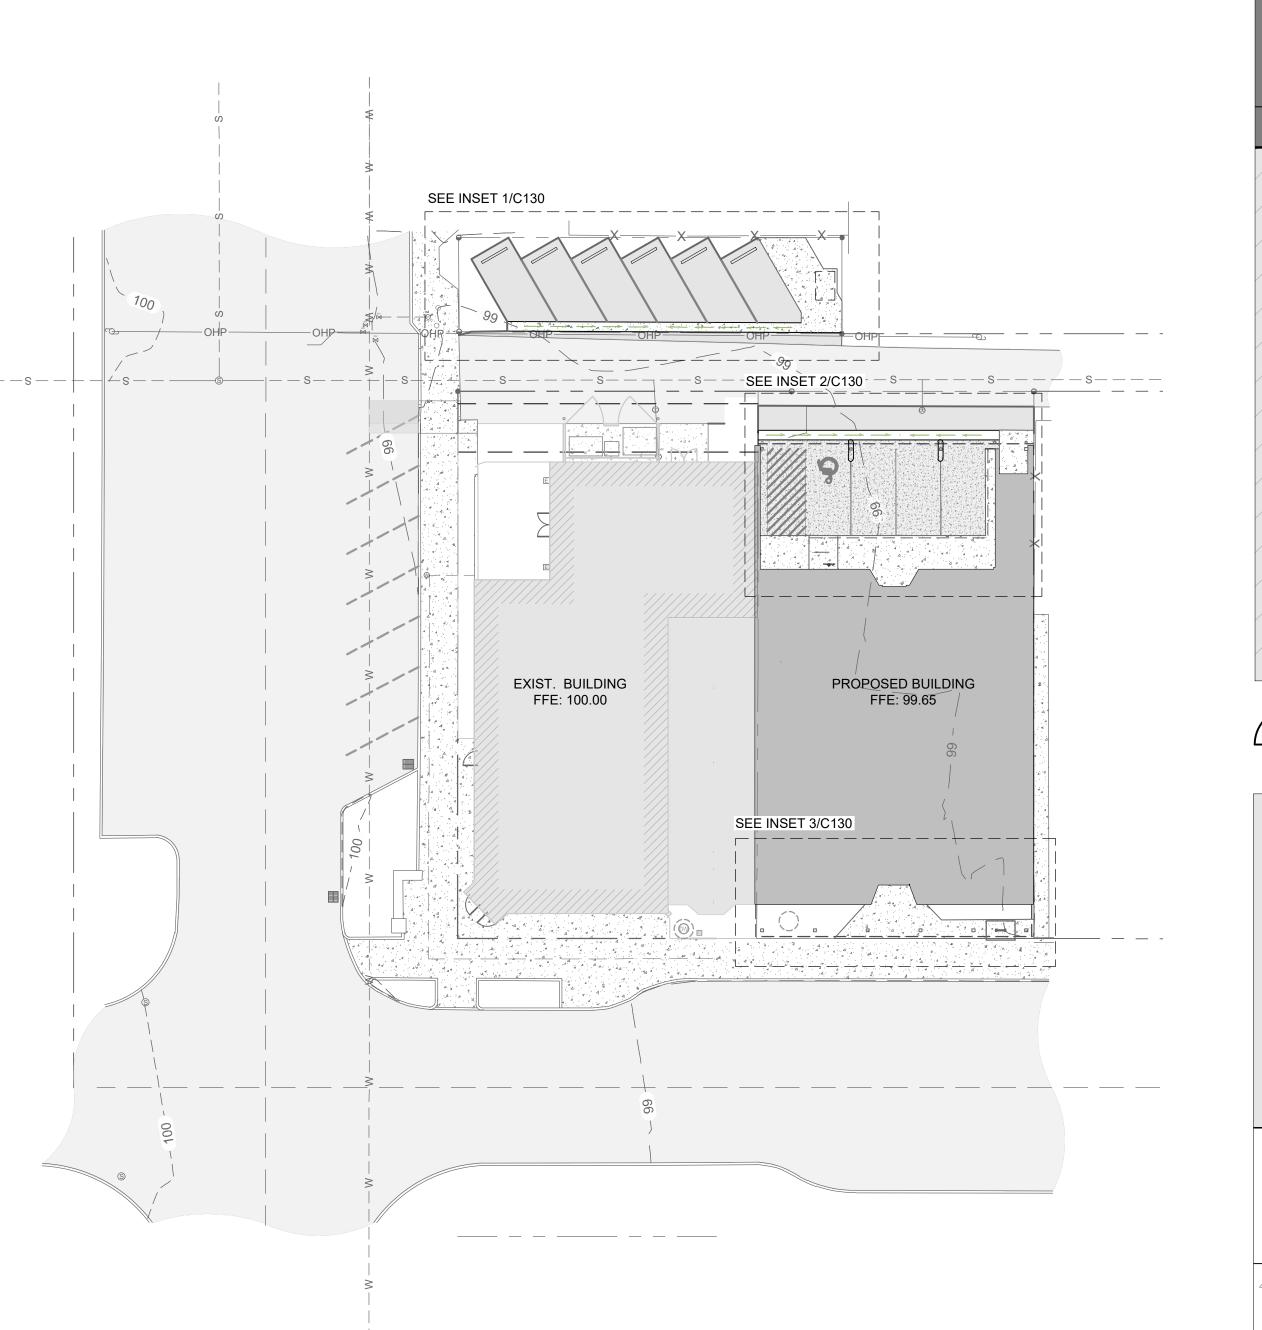



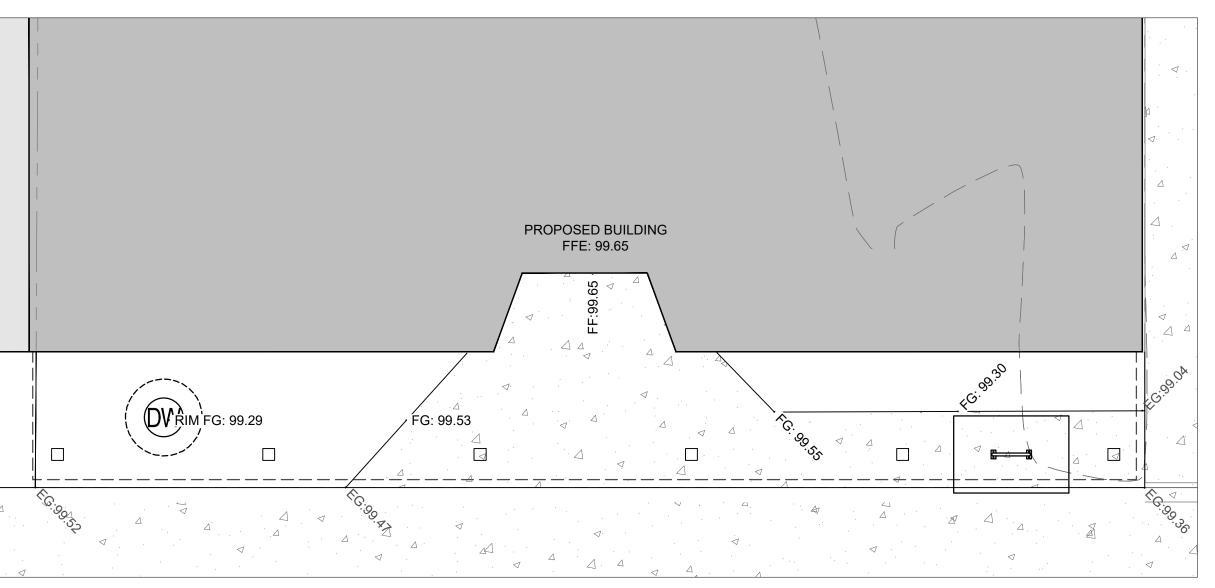

3 SOUTH BUILDING ENTRY - DETAIL

SCALE: 1" = 5'

<u>LEGEND</u>

GENERAL NOTES:

- SITE GRADING SHALL NOT PROCEED UNTIL EROSION & SEDIMENTATION CONTROL MEASURES HAVE BEEN INSTALLED.
- 2. UNLESS OTHERWISE NOTED, ALL CALLOUTS ARE TO FINISHED GRADE.
- 3. ALL TIE-INS TO EXISTING ASPHALT AND CONCRETE SHALL BE SAWCUT OR NEAT CUT BY METHOD APPROVED BY ENGINEER. PROVIDE SMOOTH TRANSITIONS TO EXISTING SURFACES.
- 4. GRADING AND DRAINAGE INFRASTRUCTURE SHALL CONFORM TO ADA REQUIREMENTS.
- 5. LIMITED COORDINATES, DIMENSIONS, AND OTHER LAYOUT INFORMATION HAVE BEEN PROVIDED ON THIS SHEET.

 CONTRACTOR WILL BE PROVIDED WITH A DIGITAL SITE MODEL TO AIR IN CONSTRUCTION STAKING AND SURVEYING. THE ENGINEER SHALL BE NOTIFIED IMMEDIATELY OF ANY DEVIATIONS BETWEEN THE DIGITAL FILES AND HARD COPY PLANS.
- 6. DETAILED GRADING AROUND LANDSCAPE FEATURES SHOWN ON LANDSCAPE PLAN PROVIDED BY OTHERS.


CONSTRUCTION NOTES:

- CONTRACTOR IS RESPONSIBLE FOR FOLLOWING ALL APPLICABLE BMP (BEST MANAGEMENT PRACTICES) DURING ALL CONSTRUCTION ACTIVITIES AND MAINTENANCE OF BMP'S DURING CONSTRUCTION.
- ENSURE POSITIVE DRAINAGE AWAY FROM ALL BUILDINGS AND BUILDING ENTRANCES.

ABBREVIATIONS:

EG: EXISTING GRADE

- FG: FINISHED GRADE
- FF: FINISH FLOOR
- TBC: TOP BACK OF CURB

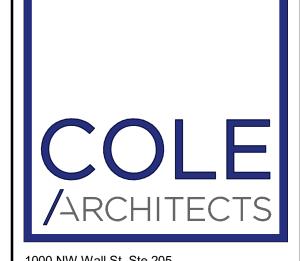

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PROJECT INFORMATION

BAKER MIXED USE

130 E CASCADE AVENUE SISTERS OREGON 97759

ISSUES

IASE	100% CD
ATE	AUGUST 4, 2023
B NUMBER	21-053-OR


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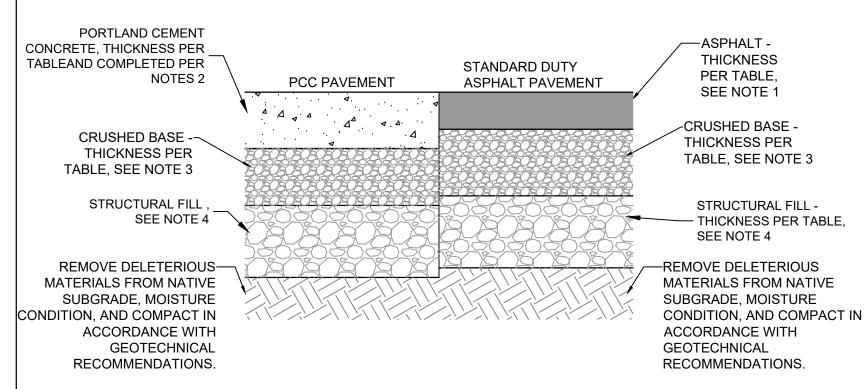
GRADING PLAN

SHEET NUMBER

C130

SCALE IN FEET



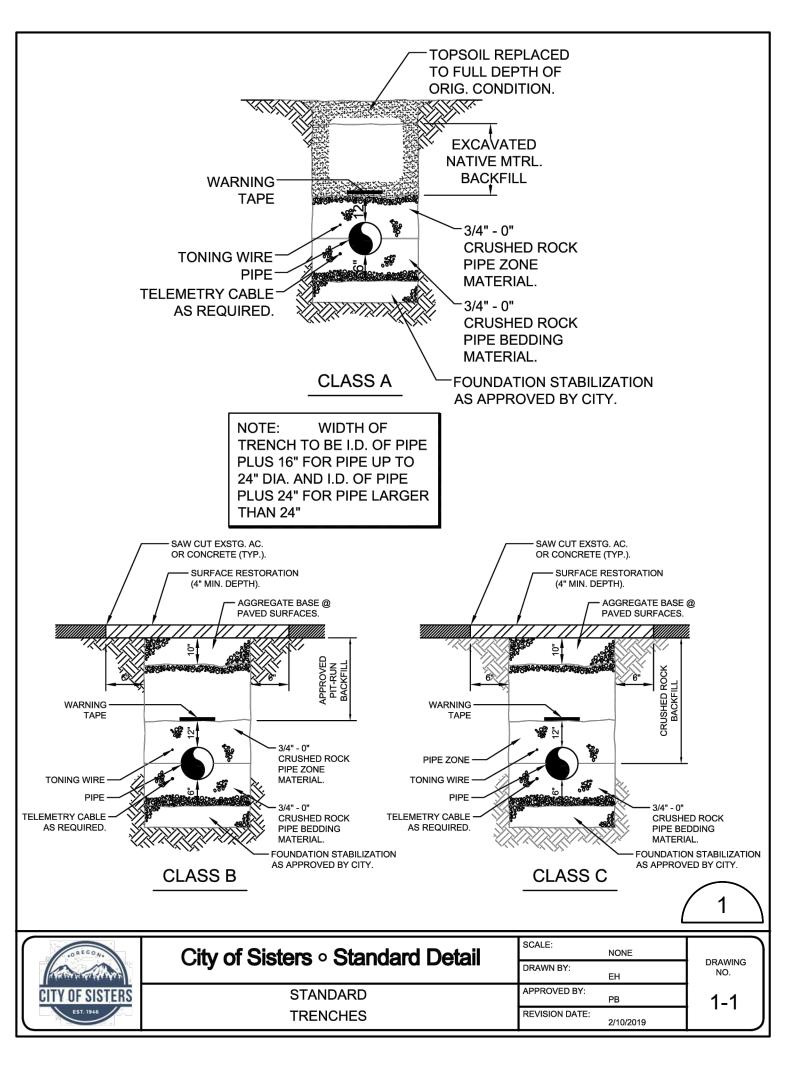

PAVEMENT SECTION - THICKNESS SCHEDULE			
CONCRETE PAVEMENT		ASPHALT CEMENT	
PORTLAND CONCRETE CEMENT	6	ASPHALT CONCRETE	3
3" MINUS CRUSHED BASE COURSE	4	3/4" MINUS CRUSHED BASE COURSE	6
STRUCTURAL FILL	8	STRUCTURAL FILL	8

1. HOT MIX ASPHALT CONCRETE, DENSITY & SURFACE REQUIREMENTS SHALL BE IN ACCORDANCE WITH OSS ASPHALT THICKNESS EXCEEDING 3" SHALL BE PLACED IN TWO UNIFORM LIFTS

- 2. PORTLAND CEMENT CONCRETE SHALL BE COMPLETED IN ACCORDANCE WITH OSS SECTION 00540.
- 3. CRUSHED BASE COURSE; $\frac{3}{4}$ " MINUS DENSE GRADED AGGREGATE PER ODOT SPECIFICATION SECTION 00641 & 02630.10; @ 92% DENSITY (+- 3% OPTIMUM MOISTURE) PER ASTM D1557
- 4. STRUCTURAL FILL PREPARATION SHALL BE COMPLETED IN ACCORDANCE WITH THE GEOTECHNICAL REPORT.
- CONTRACTOR SHALL COMPLY WITH THE GEOTECHNICAL REPORT INCLUDED IN THE CONTRACT DOCUMENTS. THE GEOTECHNCIAL REPORT SHALL GOVERN THIS SECTION.

__SLOPE`_

4" COURSE OF $\frac{3}{4}$ "

CRUSHED BASE

SCALE: NTS

COURSE COMPACTED

TO 92% OF ASTM D1557.



(2) #4 BARS CONT.

THICKENED EDGE SIDEWALK DETAIL

OR SIGN: OR7-9 & OR7-9A-

SIGN: R7-8 & R7-8P IF-

PAVEMENT-

MARKING PER

OTC FIGURE 6

6" SOLID WHITE

PER PLAN


LETTERS

VARIES, SEE PLANS

VAN ACCESSIBLE 📐

SIGN: OR7-9~

ACCESSIBLE ROUTE LOCATION

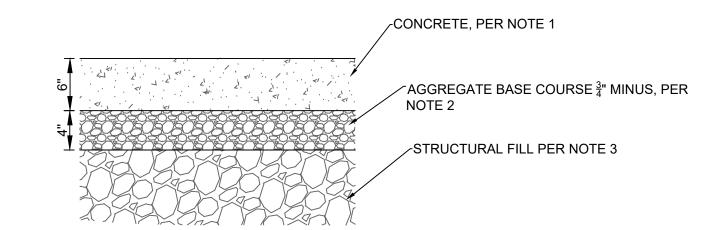


*SEE GEOTECHNICAL REPORT FOR SPECIFIC RECOMMENDATIONS

- CONCRETE SHALL MEET REQUIREMENTS OF SISTERS STANDARD SPECIFICATIONS, SECTION 213. CONCRETE SHALL CLASS 4000 PSI AND SHALL CONFORM TO ODOT CLASS 3000.
- 3. STRUCTURAL FILL SHALL BE GRANULAR INORGANIC SOIL, 2" MINUS, MEETING RECOMMENDATIONS PROVIDED IN GEOTECHNICAL REPORT. INSTALLED IN MAX. 8" LIFTS COMPACTED TO MIN. 92% DENSITY PER ASTM D1557
- 4. CONCRETE SIDEWALK SHALL HAVE A MAXIMUM CROSS SLOPE OF 2% AND RUNNING SLOPE OF 5%.
- PROVIDE PREFORMED 1/2" EXPANSION JOINT MATERIAL MEETING THE REQUIREMENTS OF AASHTO
- NOT TO EXCEED 5'. CONTRACTION JOINTS SHALL BE CONSTRUCTED BY SAWING OR SCORING. A FOR THE SPECIFIED MINIMUM DEPTH. CONTRACTION JOINTS SHALL BE A MINIMUM OF $\frac{1}{4}$ TIMES THE
- 7. PROVIDE LIGHT BROOM FINISH PERPENDICULAR TO THE CURB.



FULL HEIGHT

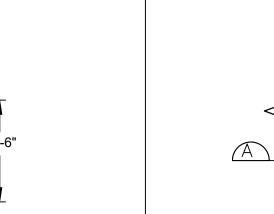

TOP OF CURB-_ NO LIP ON FLOWLINE -**SECTION "A"**


- 2. SIDEWALK CROSS-SLOPES SHALL NOT EXCEED 2%.
- 5. APPLY BROOM FINISH TO RAMPS; FINE HAIR BROOM ON LONGITUDINAL GRADES <6%, ROUGH HAIR BROOM ON LONGITUDINAL GRADES >6%.
- 6. SEE TYPICAL CONCRETE CURB AND SIDEWALK DETAIL FOR CONCRETE SPECIFICATIONS.





- 2. 3/4" MINUS AGGREGATE BASE COURSE INSTALLED PER CITY OF SISTERS STANDARD SPECIFICATIONS, PLACED IN MAX. 6" LIFTS AND COMPACTED TO MIN. 92% DENSITY PER ASTM
- M-213 AT ALL COLD JOINTS AND 30-FT INTERVALS CONTRACTION JOINTS SHALL BE SPACED THE APPROXIMATE SAME DIMENSION AS THE WIDTH, BUT TOOL SHALL BE USED WHICH LEAVE THE EDGES ROUNDED AND DESTROY AGGREGATE INTERLOCK
- SIDEWALK THICKNESS.




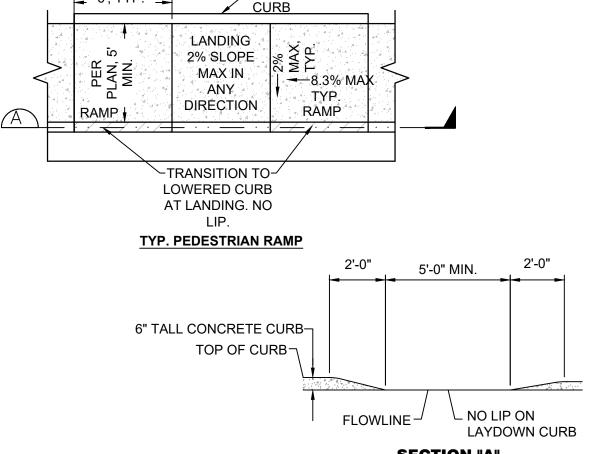



NOTES:

- 1. RAMP SLOPE SHALL NOT BE STEEPER THAN 12:1.
- 3. BEGIN RAMP SLOPE AT FLOWLINE OF GUTTER.



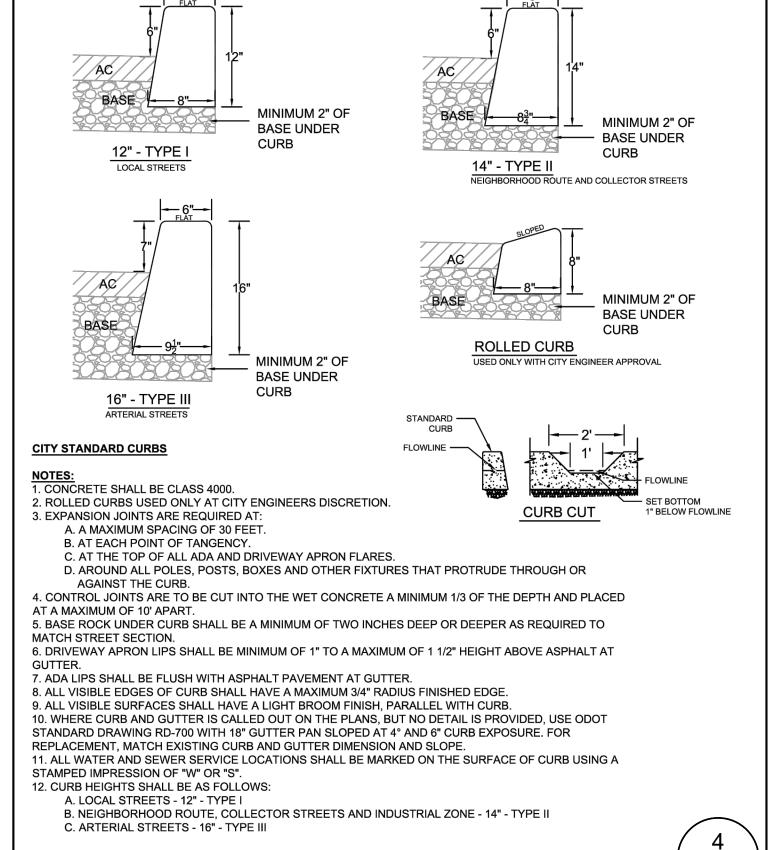

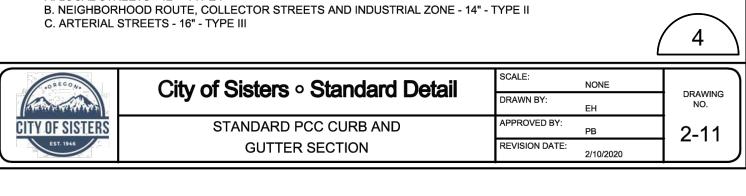

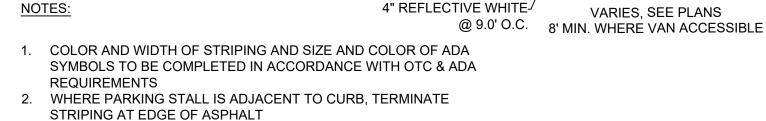

SUBGRADE

DENSITY

12"X18" SIGN PER OTC

BUILDING MOUNTED AS

SHOWN ON PLANS

STANDARDS

COMPACTED TO 95%



SHEET NUMBER

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CONSTRUCTION DOCUMENTS AND THE SITE CONDITIONS

INFORMATION REGARDING THE COMPLETE WORK OF

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1001 SW DISK DR., SUITE 110 BEND, OR 97702

541.699.5432

PROJECT INFORMATION

BAKER MIXED USE

100% CD

21-053-OR

AUGUST 4, 2023

130 E CASCADE AVENUE

SISTERS OREGON 97759

ISSUES

PHASE

JOB NUMBER

SHEET NAME

DETAILS

DATE


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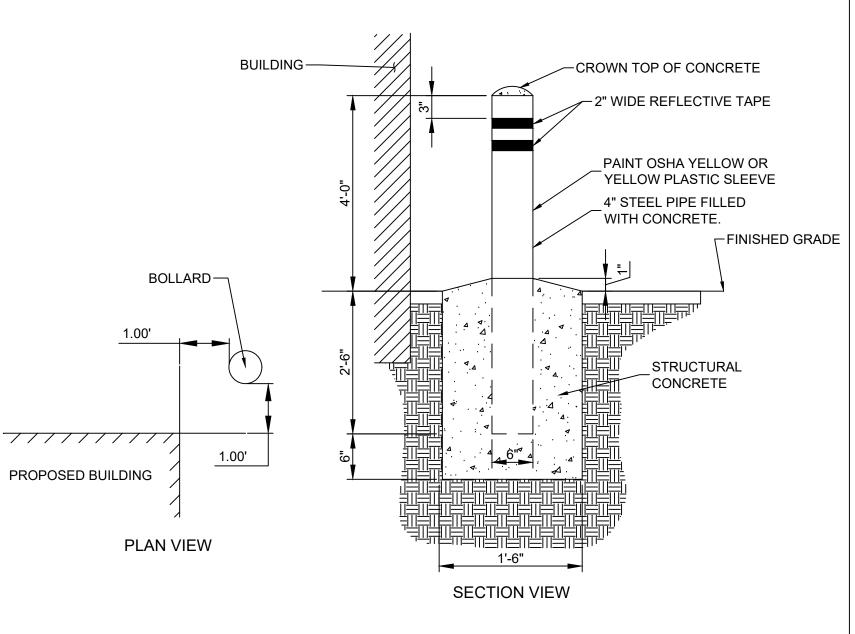
541.383.1898

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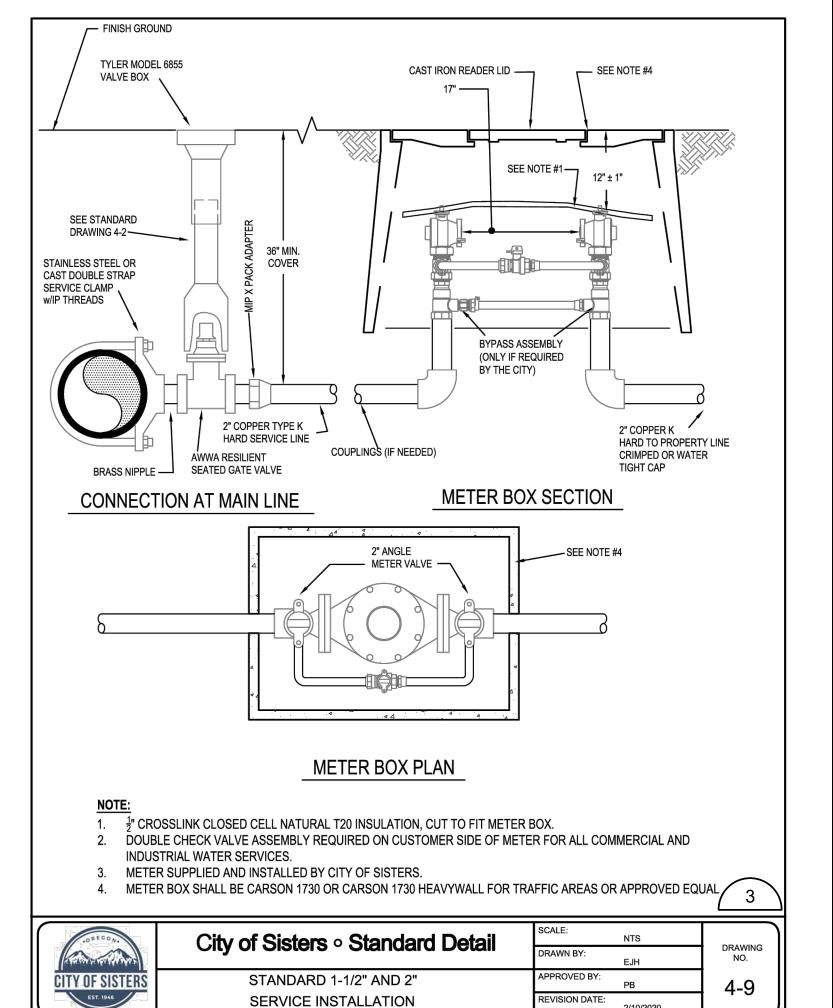
PARKING WHEEL STOP


SCALE: NTS



TYPICAL BOLLARD DETAIL

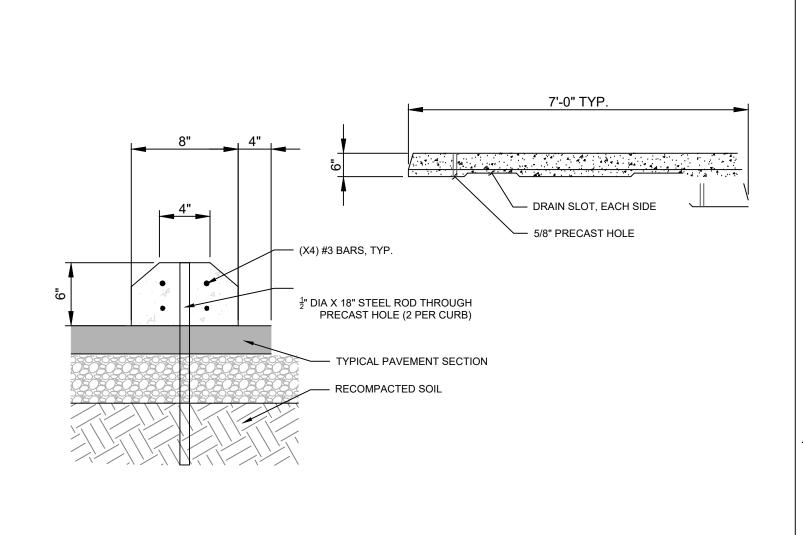SCALE: NTS



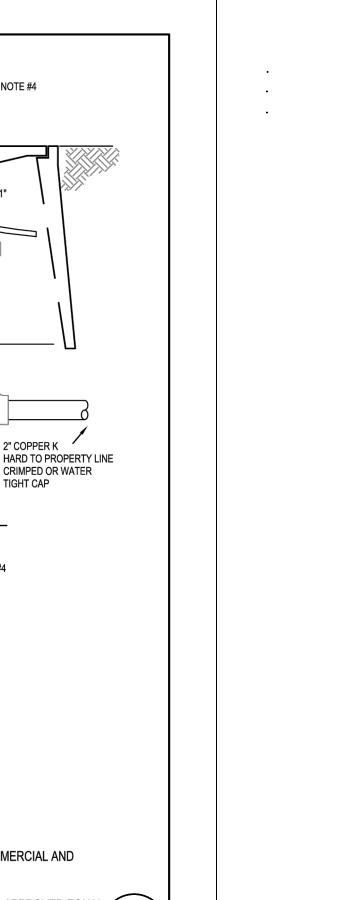



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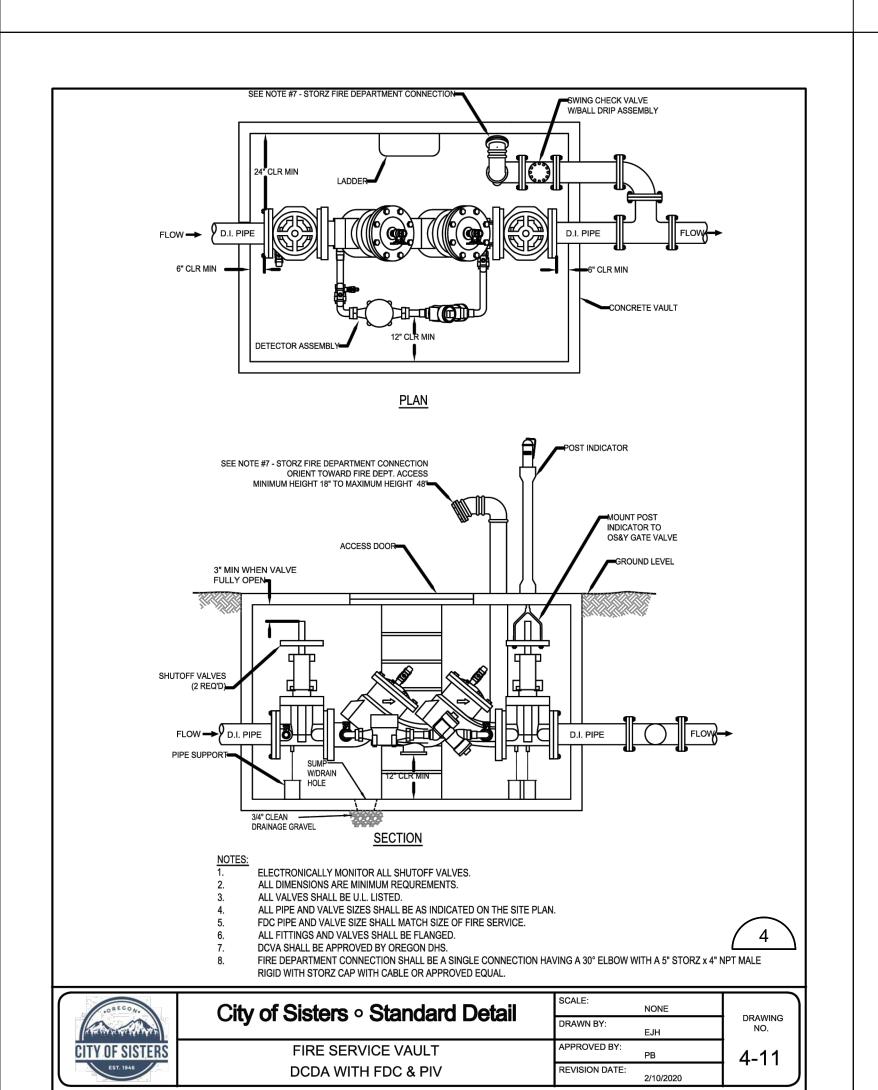
SISTERS OREGON 97759


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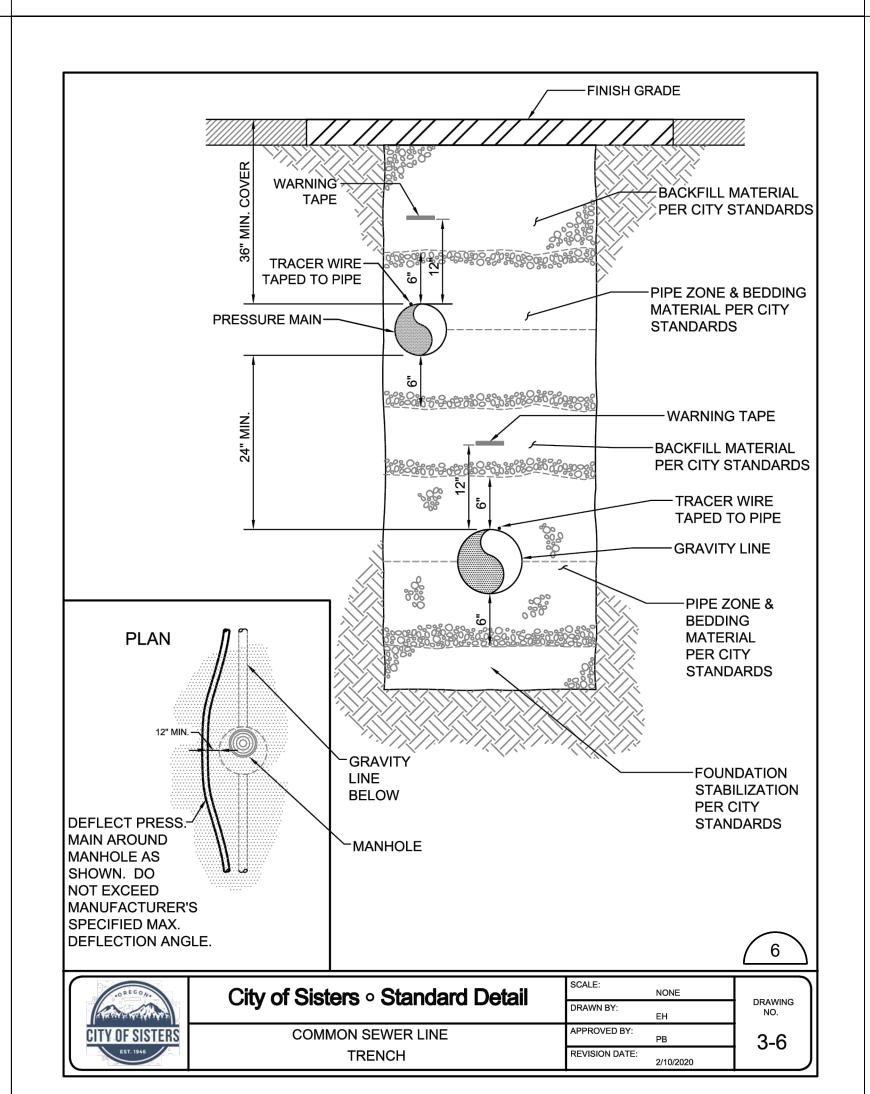
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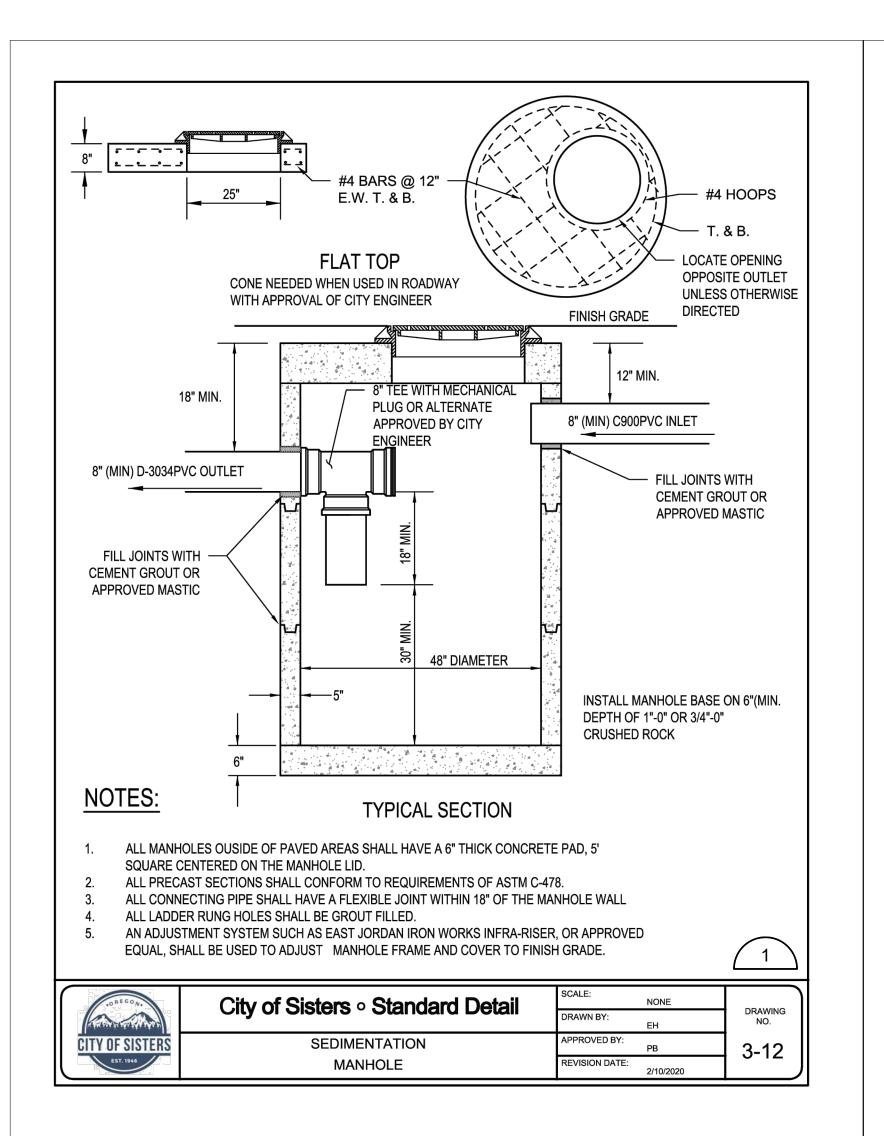
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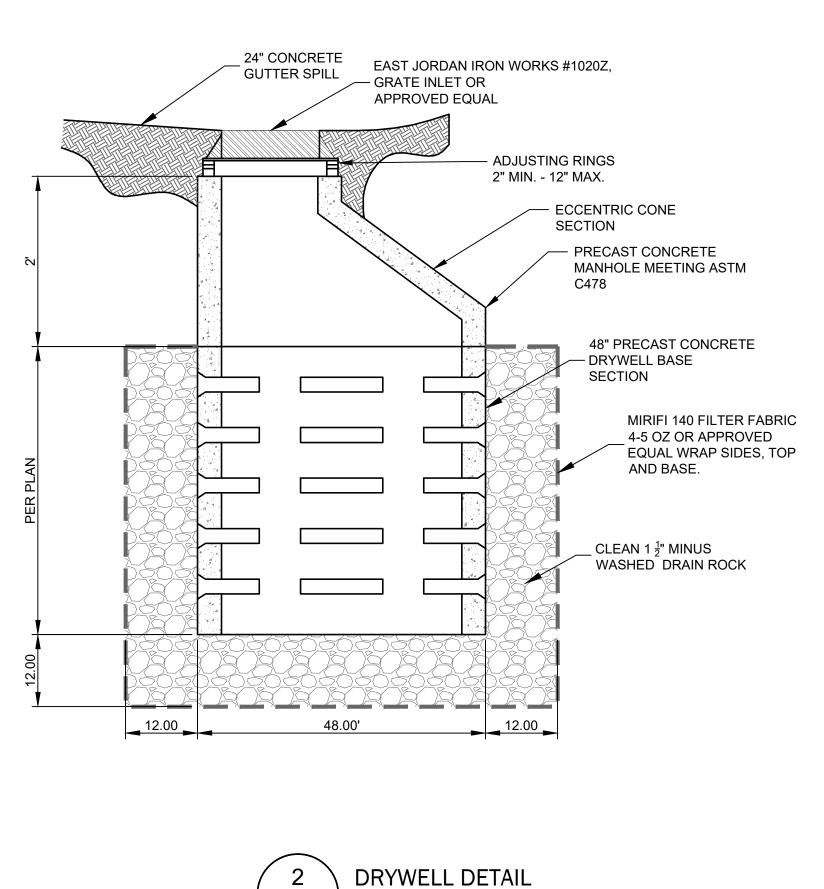
DETAILS










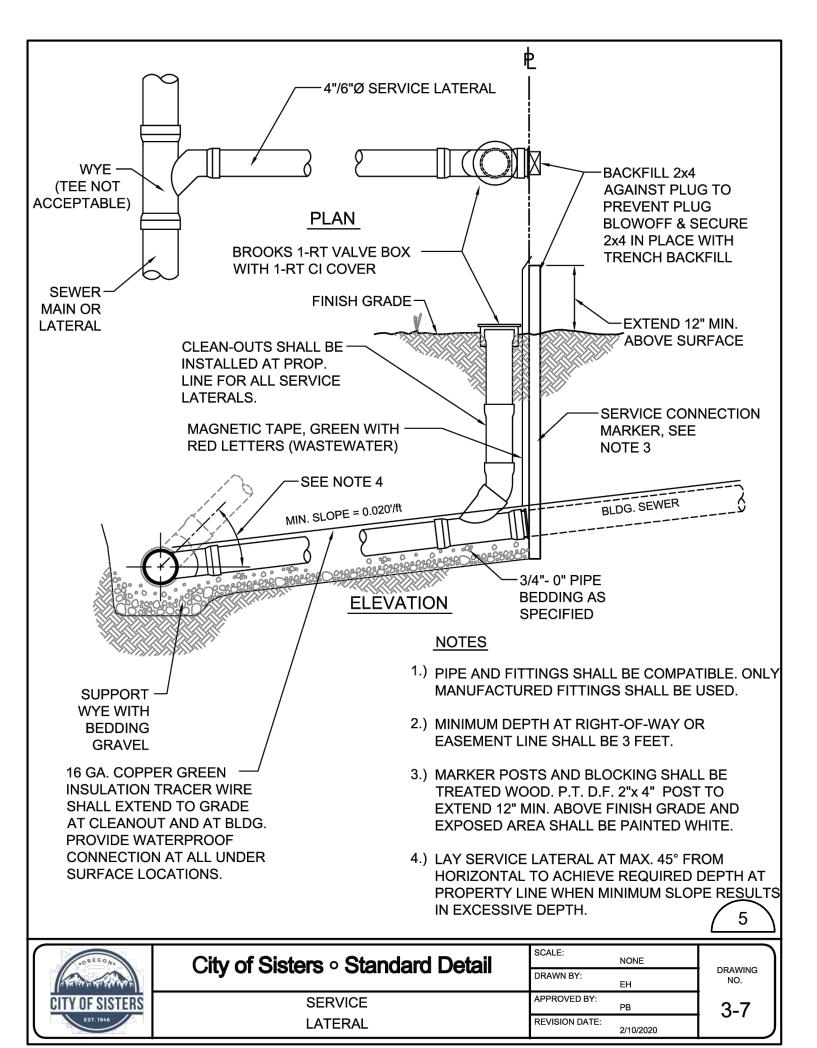

SCALE: NTS

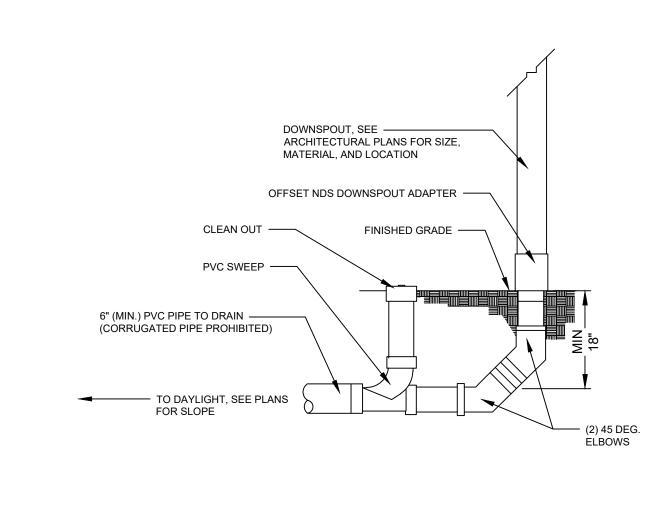

SCALE: NTS

engineers = surveyors = planners = scientists 1001 SW DISK DR., SUITE 110 ROOF DRAIN CONNECTION WITH BUILDING CLEAN OUT BEND, OR 97702 541.699.5432 PROJECT INFORMATION

VALLEY GUTTER

1. SEE CITY OF SISTERS DETAIL, DRAWING NO. 2-11, FOR CURB AND GUTTER NOTES





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