

ARCHITECTURE / PLANNING / INTERIOR DESIGN

BOISE IDAHO / BEND OREGON


Adress: 1000 NW Wall st, Bend Oregon Applicant: Greg Blackmore Client: Gary Baker

BAKER MIXED USE SISTERS OREGON

130 E CASCADE AVE, Sisters Oregon 97759




BUILDING CONCEPT / SITE PLAN

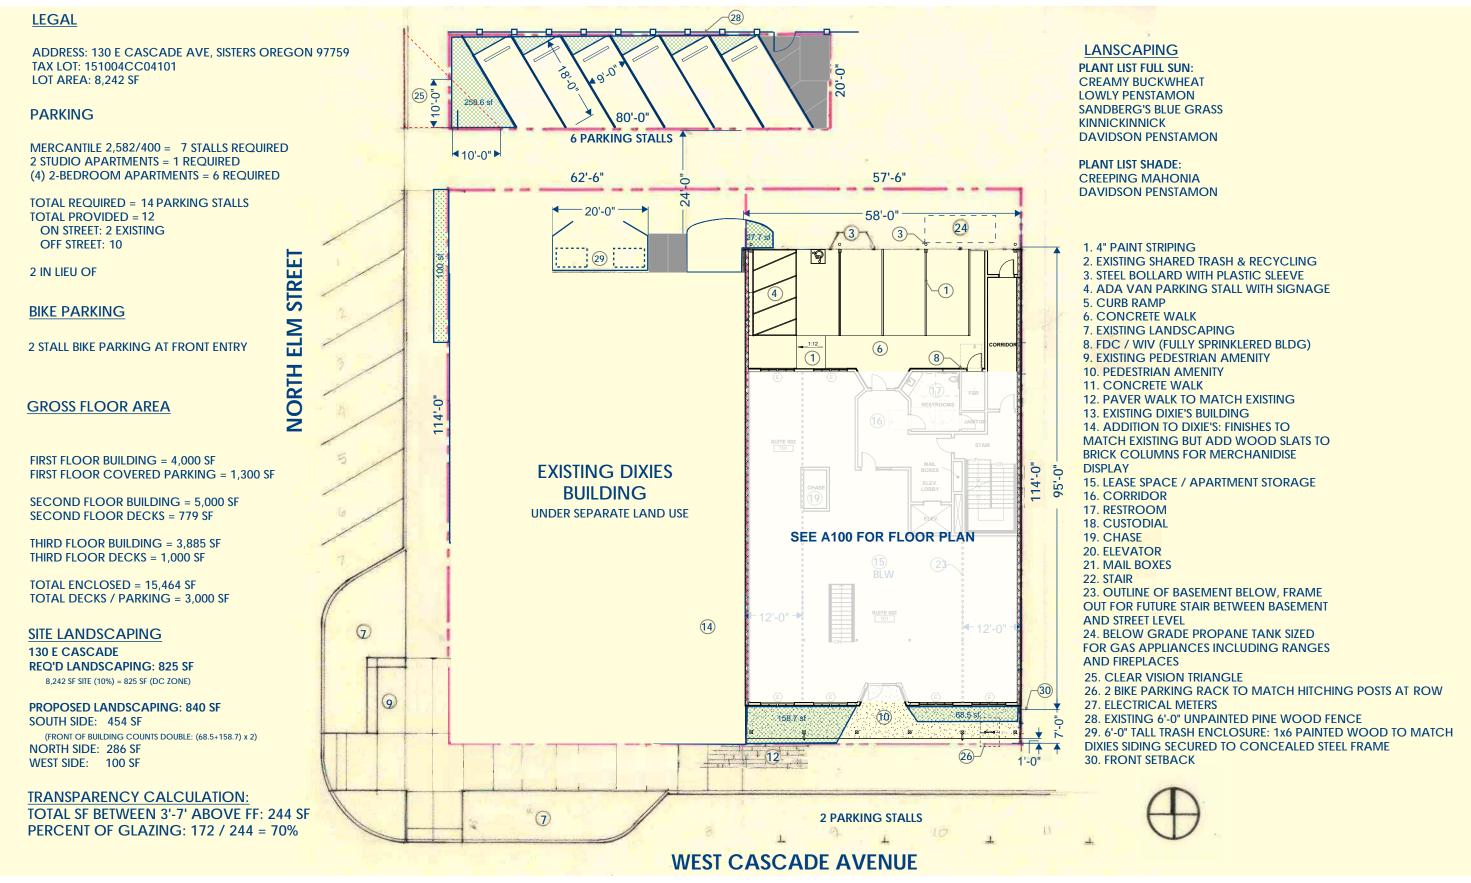





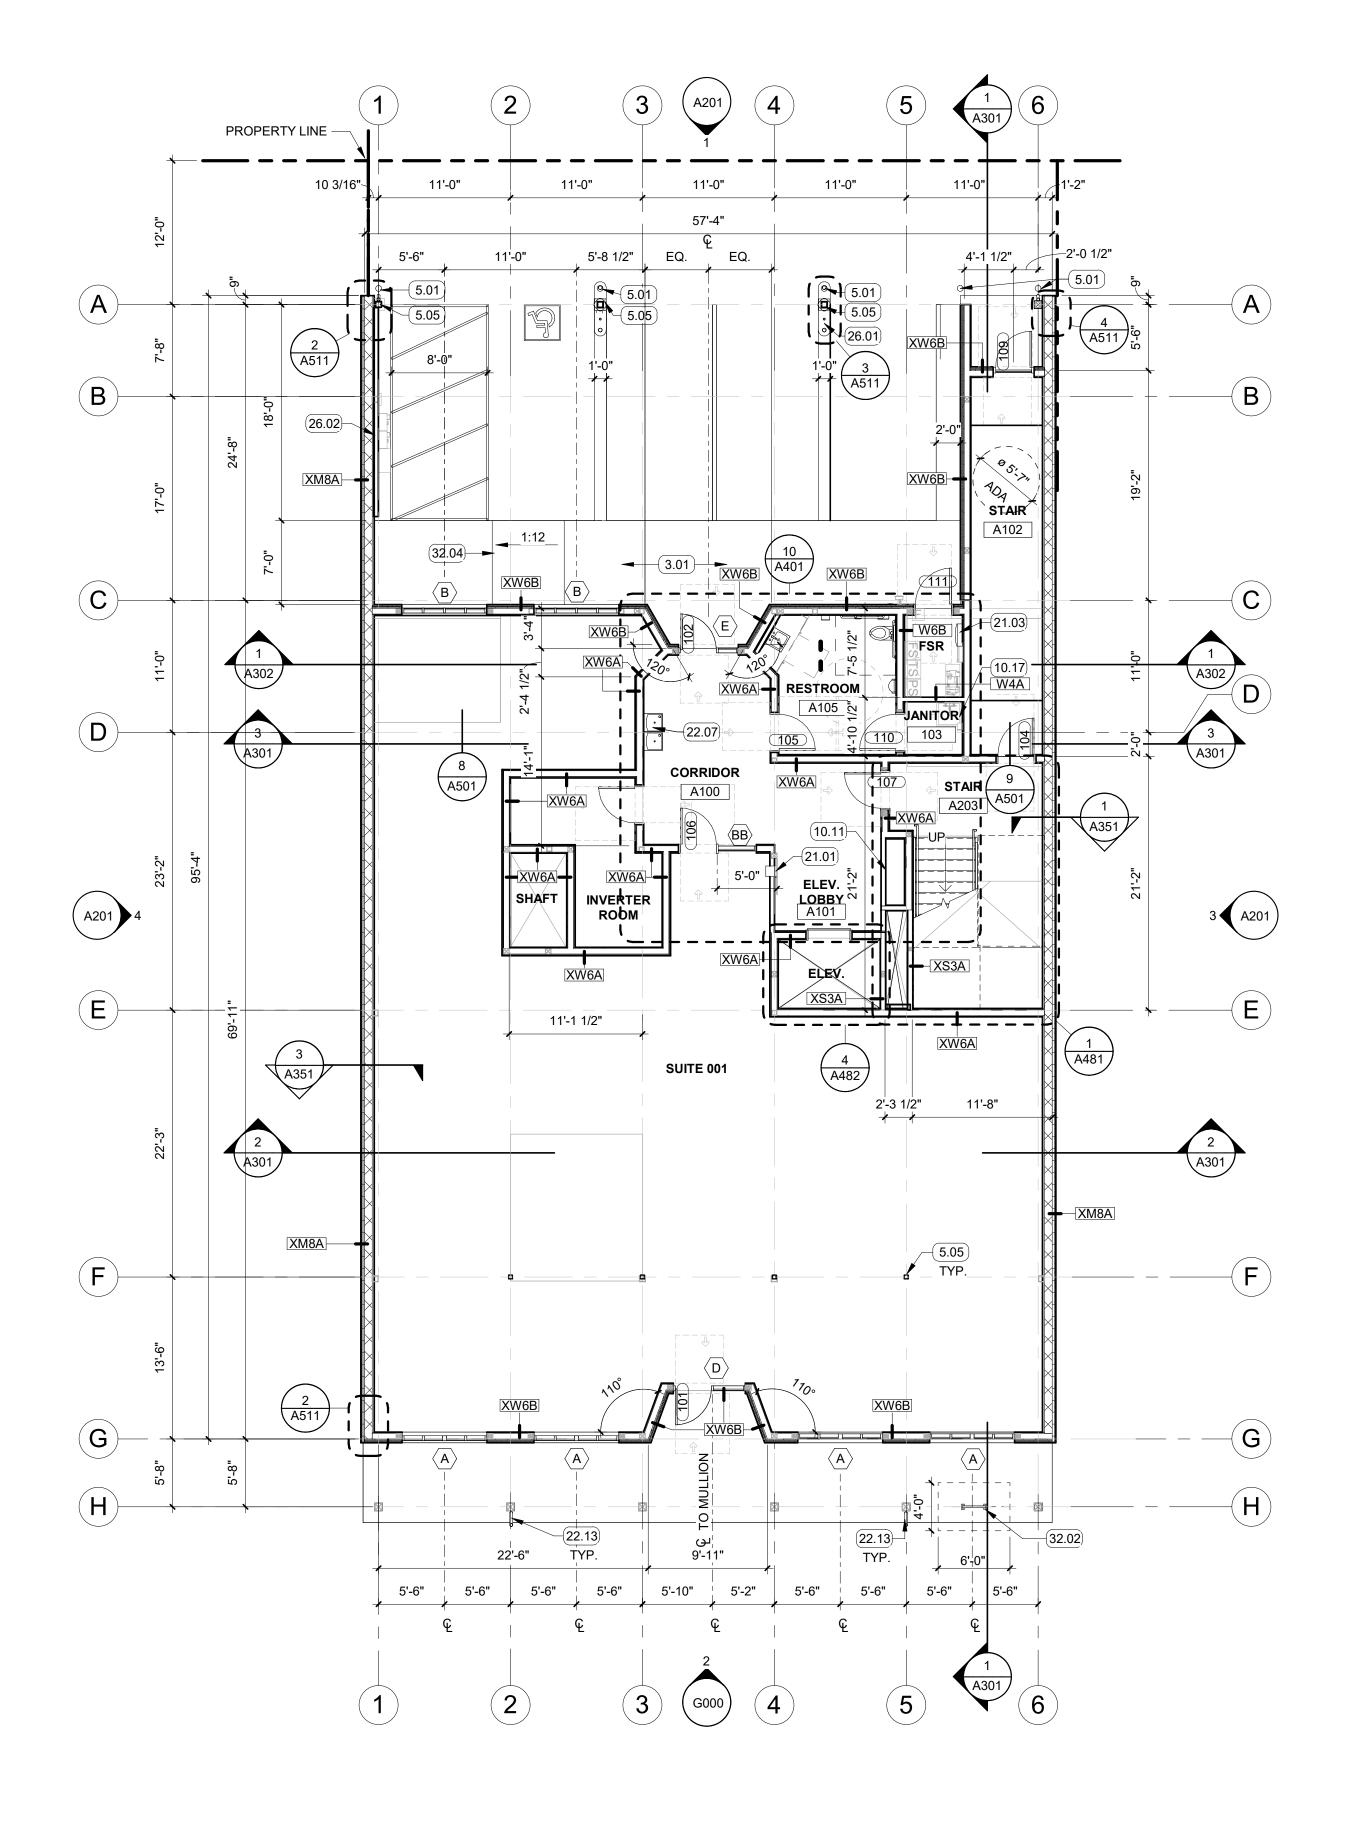



KEYNOTES

3.01 CONCRETE WALK.

BOLLARD WITH PLASTIC SLEEVE, TYP. OF 4 5.01

5.05 STEEL COLUMN, SEE STRUCTURAL

BUILT-IN MAIL BOXES, 8 LETTER SIZE COMPARTMENTS, 2 PACKAGE COMPARTMENTS, LOCKED, TO BE SELECTED BY OWNER

GENERAL NOTES

PRIOR TO PROCEEDING WITH WORK.

DISPLAY ITEMS.

PROTECT ADJACENT AREAS.

FIRE-STOPPING MATERIAL.

A. FIELD VERIFY ALL DIMENSIONS AND EXISTING CONDITIONS. NOTIFY ARCHITECT IMMEDIATELY OF ANY CONFLICTS OR DISCREPANCIES

B. CROSS REFERENCES SHOWN ON DRAWINGS DO NOT NECESSARILY INDICATE ALL LIKE CONDITIONS AND DO NOT LIMIT APPLICATION OF ANY DRAWING OR DETAIL. WHERE SPECIFIC DIMENSIONS, DETAILS,

ARCHITECT PRIOR TO PROCEEDING WITH WORK. IF DESIGN INTENT REMAINS UNCLEAR THEN PROVIDE MOST EXPENSIVE OPTION IN BID.

EQUIPMENT. BLOCKING TO MEET OR EXCEED MANUFACTURER'S

MANUFACTURER'S RECOMMENDATIONS. PROVIDE BLOCKING FOR, BUT NOT LIMITED TO THE FOLLOWING: MILLWORK, RAILING, FIRE EXTINGUISHER ACCESSORIES, WALL MOUNTED PLUMBING FIXTURES, SHELVING, ELECTRICAL EQUIPMENT, RESTROOM ACCESSORIES AND

OR DESIGN INTENT CANNOT BE DETERMINED, CONSULT THE

C. PROVIDE SOLID BLOCKING IN WALLS FOR ALL WALL HUNG

RECOMMENDATIONS. FASTEN EQUIPMENT TO WALLS PER

D. CAULK ALL COUNTERTOPS, BACKSPLASHES AND CABINETS AT LOCATIONS WHERE THEY MEET WALLS. SEAL ALL CUT-OUTS IN

E. ERECT DUST PROOF PARTITIONS AS REQUIRED BY OWNER TO

F. SEAL AROUND ALL MECHANICAL AND ELECTRICAL EQUIPMENT

G. PROVIDE 4" DOOR JAMBS FROM FACE-OF-FINISH AT ADJACENT

WALLS ON THE HINGE SIDE OR UNLESS OTHERWISE INDICATED.

H. DIMENSIONS ARE TO GRID LINE OR FACE OF STRUCTURAL MEMBER UNLESS OTHERWISE NOTED. DOOR & WINDOW OPENING

I. PRIOR TO POURING CONCRETE SLABS PROVIDE SHOP DRAWING OF

CONTROL AND EXPANSION JOINT LAYOUT FOLLOWING BEST

K. ALL RESIDENTIAL UNITS TO COMPLY WITH OREGON ACCESSIBILITY

CODE 2017 CHAPTER 11: 1104 FOR TYPE B UNITS. SEE SHEET G002

DIMENSIONS ARE TO ROUGH OPENING OR CENTERLINE OF OPENING. CONCRETE AND BRICK DIMENSIONS ARE GIVEN TO THE FACE OF CONCRETE OR MASONRY AND TO THE FACE OF ROUGH OPENINGS.

PENETRATIONS AT WALLS. AT RATED WALLS USE A U.L. APPROVED

MOP SINK, SEE PLUMBING FIRE EXTINQUISHER CABINET, FULLY RECESSED

FIRE ALARM PANEL

DRINKING FOUNTAIN

RAIN WATER LEADER, TYP EV CHARGING STATION WITH TWO CONNECTIONS

ELECTRICAL METERS, SEE ELEC.

BICYCLE RACK, MATCHING CITY OF SISTERS STANDARD 32.04 1:12 ADA COMPLIANT RAMP, SEE CIVIL



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NOT FOR CONSTRUCTION

CONSTRUCTION DOCUMENTS AND THE SITE CONDITIONS. INFORMATION REGARDING THE COMPLETE WORK OF SPECIFIC TRADES IS DISPERSED THROUGHOUT THE ENTIRE DOCUMENT SET AND CANNOT BE ACCURATELY DETERMINED BY REFERENCE TO OTHER THAN COMPLETE DOCUMENT SET.

CONSULTANT

PROJECT INFORMATION

BAKER MIXED USE

130 E CASCADE AVENUE SISTERS OREGON 97759

WALL TYPE LEGEND

FOR ACCESIBILITY CLEARANCES AND REQUIREMERNTS.

J. ALL CASEWORK TO BE DESIGN-BUILD, COORDINATE ALL CLEARANCES AND TRADES PRIOR TO ROUGH-IN.

PARTITION - NON RAT
SMOKE RATED
1-HOUR FIRE RATED
2-HOUR FIRE RATED
3-HOUR FIRE RATED

ISSUES

January 16th, 202
21-053-C


DESCRIPTION

SHEET NAME

MARK DATE

FLOOR PLAN -LEVEL 01

SHEET NUMBER

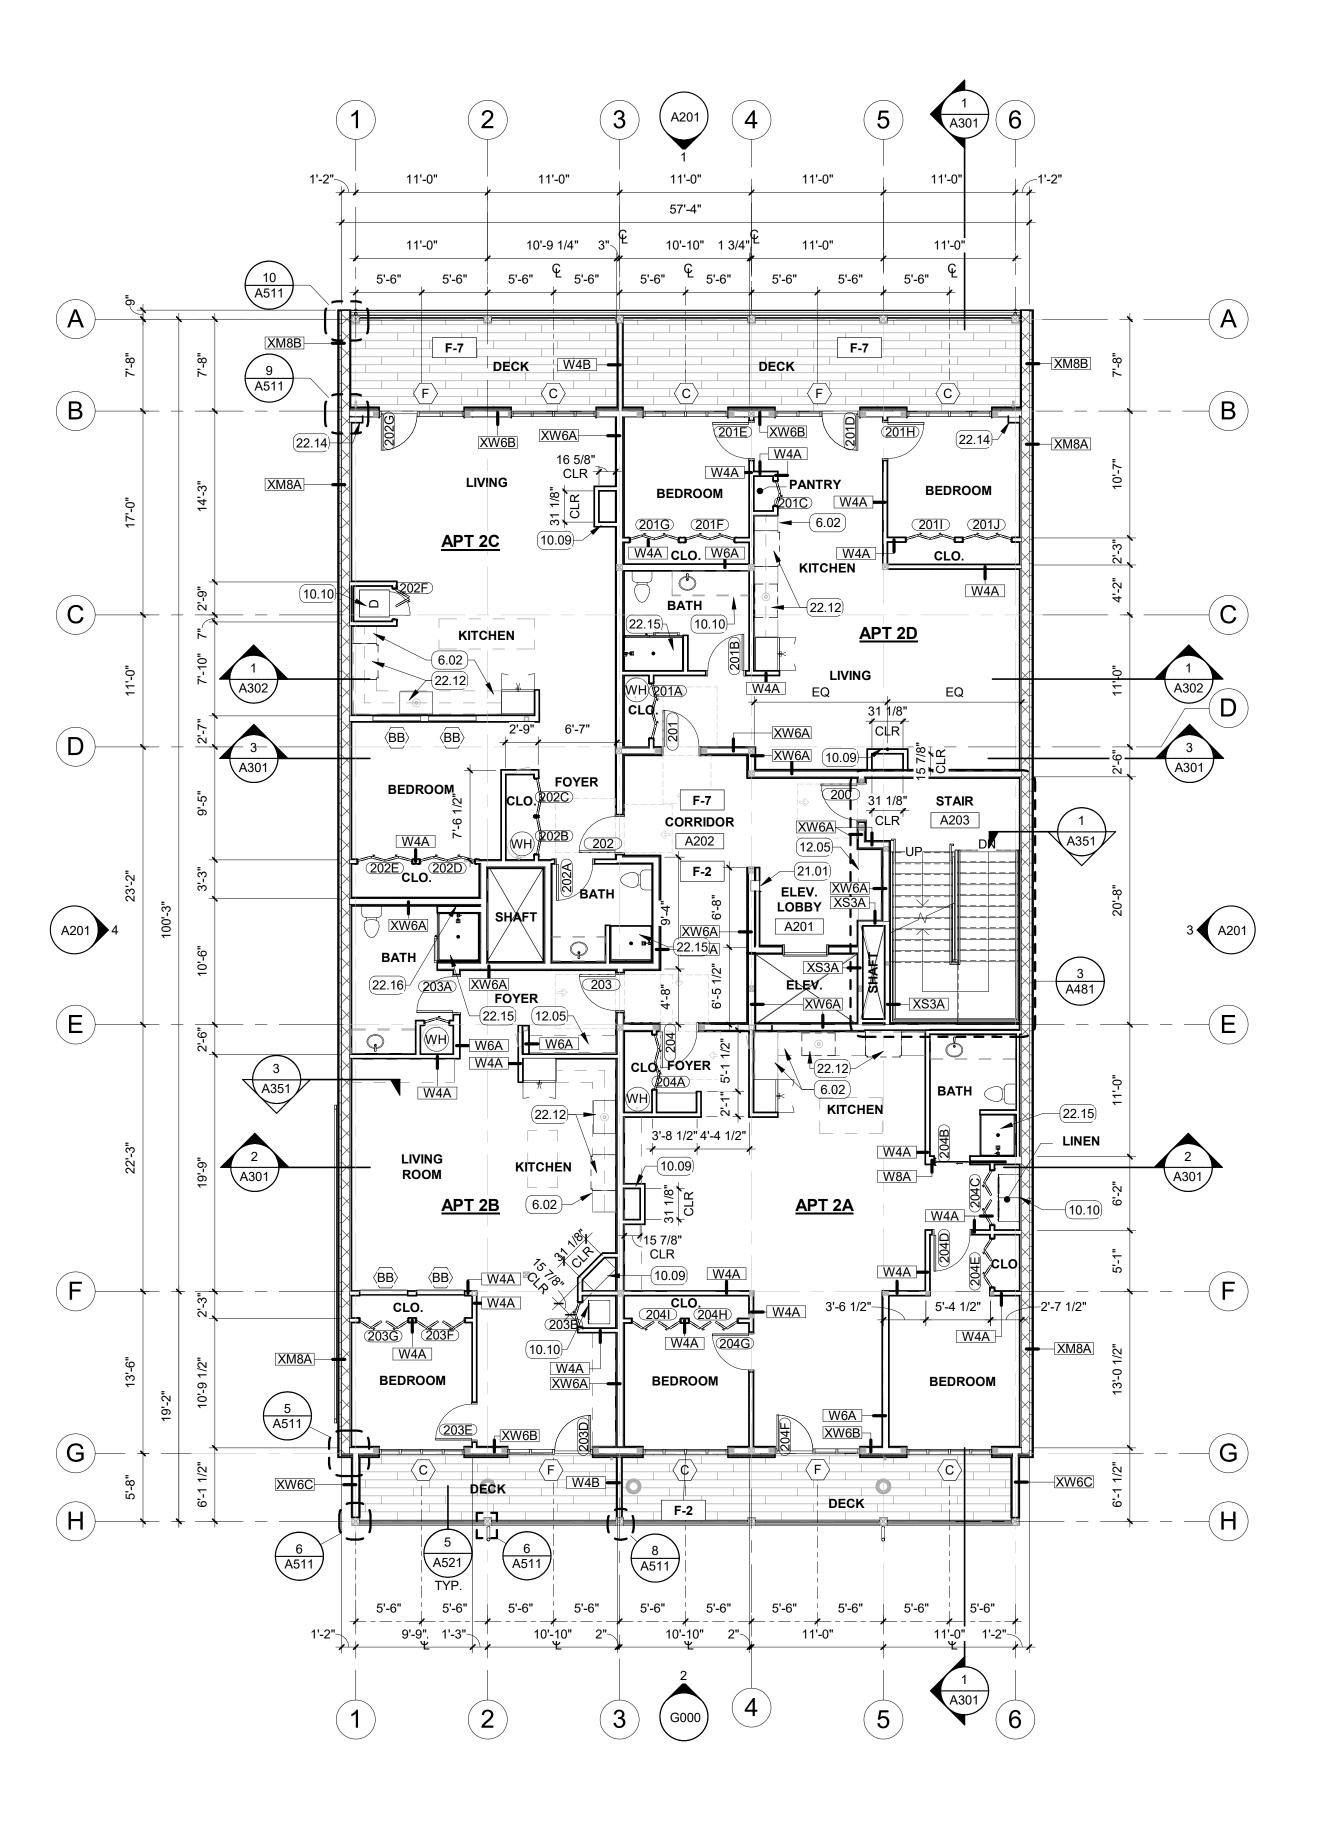

FLOOR PLAN - LEVEL 02

SCALE: 1/8" = 1'-0"



KEYNOTES

- 6.02 CASEWORK, DESIGN-BUILD
 10.09 ELECTRIC FAUX FIREPLACE FRAME CLEARANCES PER
 - MANUFACTURER, TYP.

 10 WASHER AND DRYER
 - 10 WASHER AND DRYER
 D5 BUILT-IN BENCH, DESIGN BUILD
- 21.01 FIRE EXTINQUISHER CABINET, FULLY RECESSED
- 22.12 SINK AND RANGE LOCATION TBD BY CLIENT, CONTRACTOR TO COORDINATE LOCATION WITH PLUMBING PRIOR TO ROUGH-IN
 22.14 2x6 FURRING FOR HOSE BIB PIPING, FINISH WITH 5/8" GYP. BD,
- TYP.

 22.15 ALL SHOWERS TO BE PRE-EAR PANS WITH THE WALLS AN
- 22.15 ALL SHOWERS TO BE PRE-FAB PANS WITH TILE WALLS AND GLASS DOORS
- 22.16 RECESSED SHELVING IN SHOWER WALL

GENERAL NOTES

PRIOR TO PROCEEDING WITH WORK.

DISPLAY ITEMS.

COUNTERTOPS.

PROTECT ADJACENT AREAS.

FIRE-STOPPING MATERIAL.

A. FIELD VERIFY ALL DIMENSIONS AND EXISTING CONDITIONS. NOTIFY ARCHITECT IMMEDIATELY OF ANY CONFLICTS OR DISCREPANCIES

B. CROSS REFERENCES SHOWN ON DRAWINGS DO NOT NECESSARILY

OR DESIGN INTENT CANNOT BE DETERMINED, CONSULT THE

C. PROVIDE SOLID BLOCKING IN WALLS FOR ALL WALL HUNG

INDICATE ALL LIKE CONDITIONS AND DO NOT LIMIT APPLICATION OF ANY DRAWING OR DETAIL. WHERE SPECIFIC DIMENSIONS, DETAILS,

ARCHITECT PRIOR TO PROCEEDING WITH WORK. IF DESIGN INTENT

EQUIPMENT. BLOCKING TO MEET OR EXCEED MANUFACTURER'S RECOMMENDATIONS. FASTEN EQUIPMENT TO WALLS PER

MANUFACTURER'S RECOMMENDATIONS. PROVIDE BLOCKING FOR,

BUT NOT LIMITED TO THE FOLLOWING: MILLWORK, RAILING, FIRE EXTINGUISHER ACCESSORIES, WALL MOUNTED PLUMBING FIXTURES, SHELVING, ELECTRICAL EQUIPMENT, RESTROOM ACCESSORIES AND

D. CAULK ALL COUNTERTOPS, BACKSPLASHES AND CABINETS AT LOCATIONS WHERE THEY MEET WALLS. SEAL ALL CUT-OUTS IN

E. ERECT DUST PROOF PARTITIONS AS REQUIRED BY OWNER TO

F. SEAL AROUND ALL MECHANICAL AND ELECTRICAL EQUIPMENT

G. PROVIDE 4" DOOR JAMBS FROM FACE-OF-FINISH AT ADJACENT WALLS ON THE HINGE SIDE OR UNLESS OTHERWISE INDICATED.

H. DIMENSIONS ARE TO GRID LINE OR FACE OF STRUCTURAL MEMBER UNLESS OTHERWISE NOTED. DOOR & WINDOW OPENING

DIMENSIONS ARE TO ROUGH OPENING OR CENTERLINE OF OPENING.

CONCRETE AND BRICK DIMENSIONS ARE GIVEN TO THE FACE OF CONCRETE OR MASONRY AND TO THE FACE OF ROUGH OPENINGS.

I. PRIOR TO POURING CONCRETE SLABS PROVIDE SHOP DRAWING OF CONTROL AND EXPANSION JOINT LAYOUT FOLLOWING BEST

J. ALL CASEWORK TO BE DESIGN-BUILD, COORDINATE ALL

CLEARANCES AND TRADES PRIOR TO ROUGH-IN.

WALL TYPE LEGEND

PENETRATIONS AT WALLS. AT RATED WALLS USE A U.L. APPROVED

REMAINS UNCLEAR THEN PROVIDE MOST EXPENSIVE OPTION IN BID.



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CONSULTANT

PROJECT INFORMATION

BAKER MIXED USE

130 E CASCADE AVENUE SISTERS OREGON 97759

K. ALL RESIDENTIAL UNITS TO COMPLY WITH OREGON ACCESSIBILITY CODE 2017 CHAPTER 11: 1104 FOR TYPE B UNITS. SEE SHEET G002 FOR ACCESIBILITY CLEARANCES AND REQUIREMERNTS.

PARTITION - NON RATE
SMOKE RATED
1-HOUR FIRE RATED
2-HOUR FIRE RATED

3-HOUR FIRE RATED

ISSUES


PHASE	100% CD's
DATE	August 4th, 2023
JOB NUMBER	21-053-OR
-	

MARK DATE DESCRIPTION

SHEET NAME

FLOOR PLAN -LEVEL 02

SHEET NUMBER

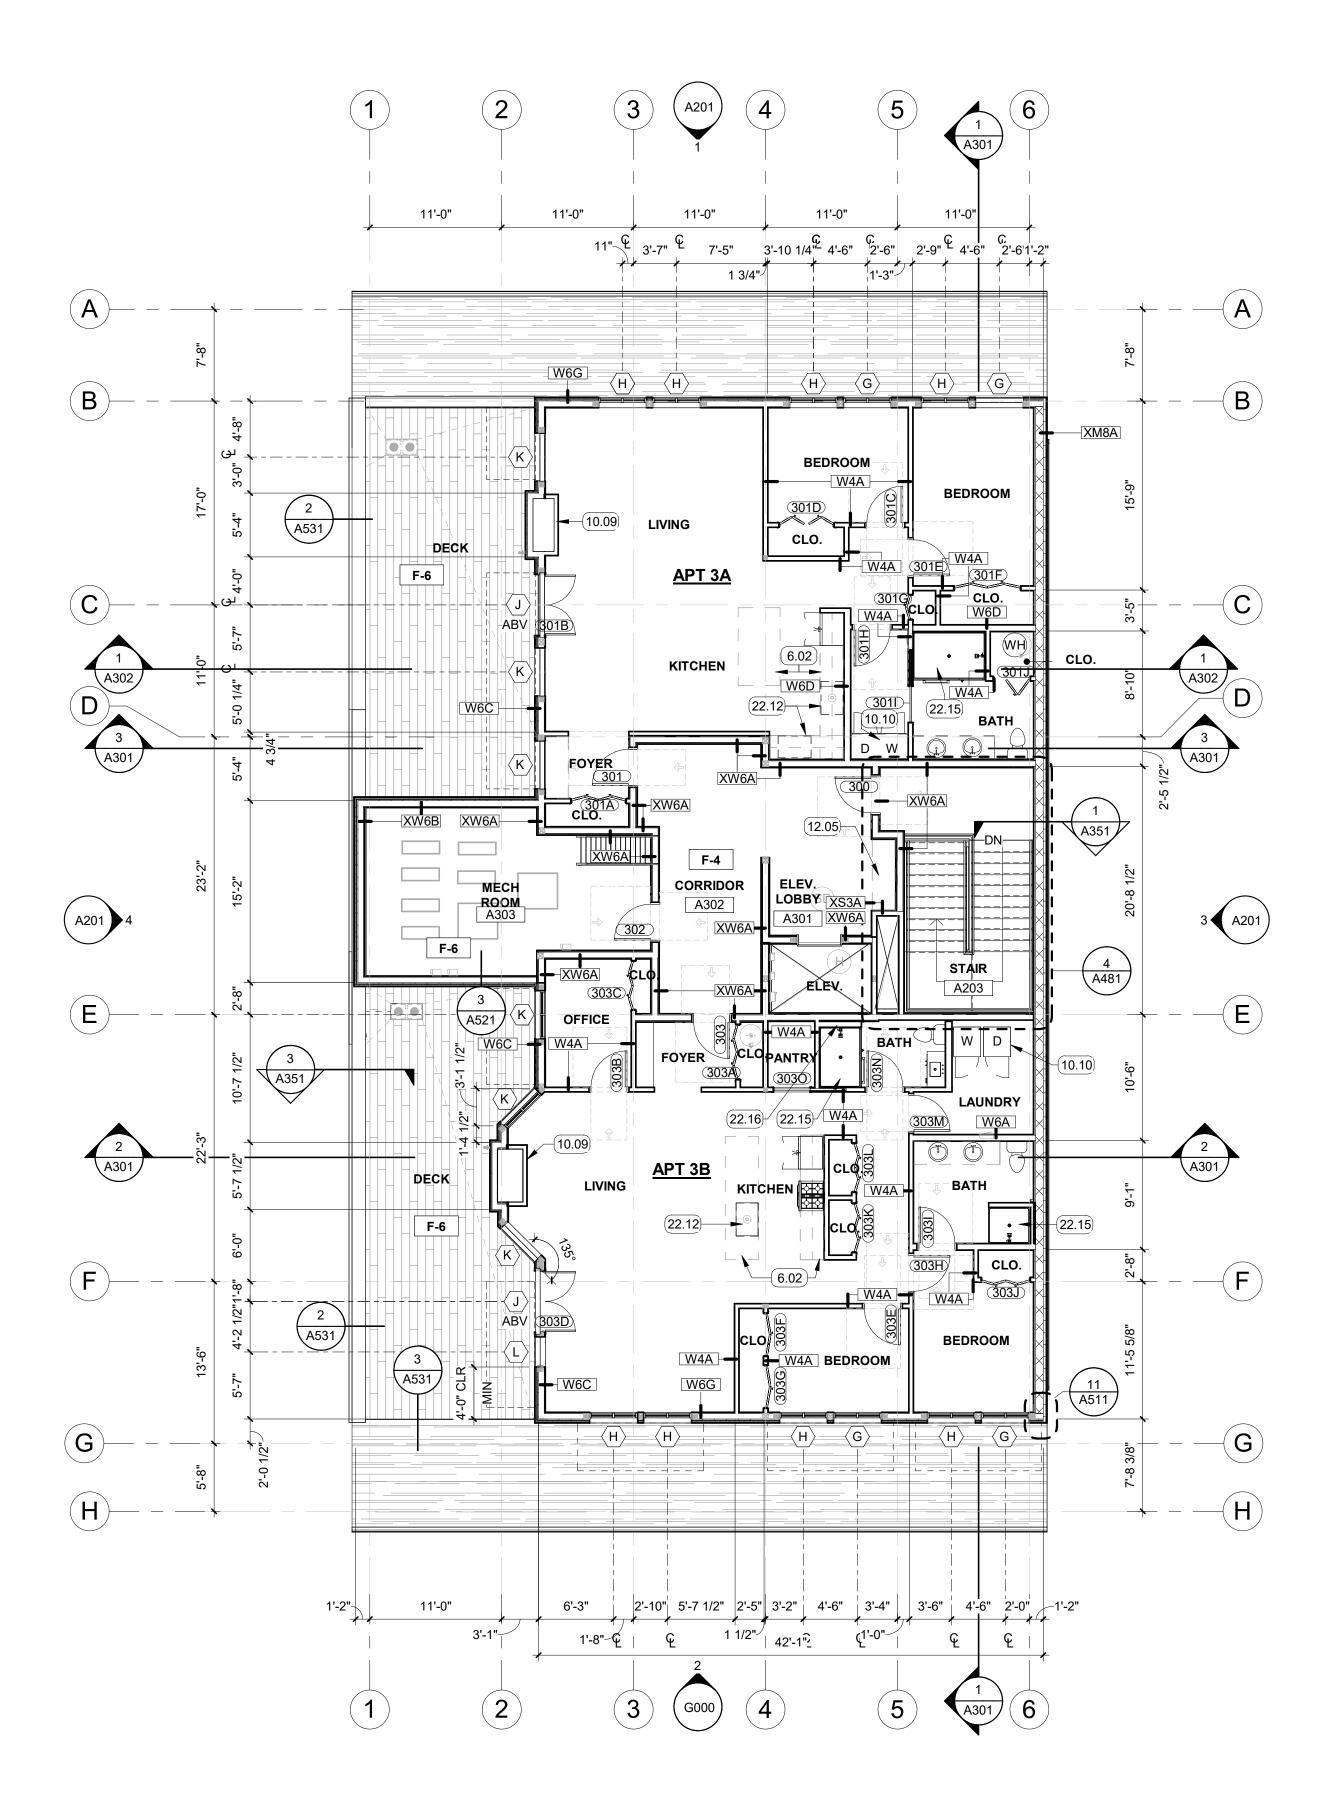

1 FLOOR PLAN - LEVEL 03
SCALE: 1/8" = 1'-0"



KEYNOTES

6.02 CASEWORK, DESIGN-BUILD
10.09 ELECTRIC FAUX FIREPLACE FRAME CLEARANCES PER

MANUFACTURER, TYP.

10 WASHER AND DRYER

10.10 WASHER AND DRYER

12.05 BUILT-IN BENCH, DESIGN BUILD
 22.12 SINK AND RANGE LOCATION TBD BY CLIENT, CONTRACTOR TO COORDINATE LOCATION WITH PLUMBING PRIOR TO ROUGH-IN

22.15 ALL SHOWERS TO BE PRE-FAB PANS WITH TILE WALLS AND GLASS DOORS

22.16 RECESSED SHELVING IN SHOWER WALL

GENERAL NOTES

PRIOR TO PROCEEDING WITH WORK.

COUNTERTOPS.

PRACTICES.

PROTECT ADJACENT AREAS.

FIRE-STOPPING MATERIAL.

A. FIELD VERIFY ALL DIMENSIONS AND EXISTING CONDITIONS. NOTIFY

B. CROSS REFERENCES SHOWN ON DRAWINGS DO NOT NECESSARILY

OR DESIGN INTENT CANNOT BE DETERMINED, CONSULT THE

C. PROVIDE SOLID BLOCKING IN WALLS FOR ALL WALL HUNG

D. CAULK ALL COUNTERTOPS, BACKSPLASHES AND CABINETS AT LOCATIONS WHERE THEY MEET WALLS. SEAL ALL CUT-OUTS IN

E. ERECT DUST PROOF PARTITIONS AS REQUIRED BY OWNER TO

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CODE 2017 CHAPTER 11: 1104 FOR TYPE B UNITS. SEE SHEET G002

CONTROL AND EXPANSION JOINT LAYOUT FOLLOWING BEST

J. ALL CASEWORK TO BE DESIGN-BUILD, COORDINATE ALL

FOR ACCESIBILITY CLEARANCES AND REQUIREMERNTS.

CLEARANCES AND TRADES PRIOR TO ROUGH-IN.

WALL TYPE LEGEND

PARTITION - NON RATED

SMOKE RATED

1-HOUR FIRE RATED

2-HOUR FIRE RATED

3-HOUR FIRE RATED

DIMENSIONS ARE TO ROUGH OPENING OR CENTERLINE OF OPENING. CONCRETE AND BRICK DIMENSIONS ARE GIVEN TO THE FACE OF CONCRETE OR MASONRY AND TO THE FACE OF ROUGH OPENINGS.

PENETRATIONS AT WALLS. AT RATED WALLS USE A U.L. APPROVED

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EQUIPMENT. BLOCKING TO MEET OR EXCEED MANUFACTURER'S RECOMMENDATIONS. FASTEN EQUIPMENT TO WALLS PER

MANUFACTURER'S RECOMMENDATIONS. PROVIDE BLOCKING FOR, BUT NOT LIMITED TO THE FOLLOWING: MILLWORK, RAILING, FIRE EXTINGUISHER ACCESSORIES, WALL MOUNTED PLUMBING FIXTURES, SHELVING, ELECTRICAL EQUIPMENT, RESTROOM ACCESSORIES AND

REMAINS UNCLEAR THEN PROVIDE MOST EXPENSIVE OPTION IN BID.

ARCHITECT IMMEDIATELY OF ANY CONFLICTS OR DISCREPANCIES



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PROJECT INFORMATION

BAKER MIXED USE

130 E CASCADE AVENUE SISTERS OREGON 97759

K. ALL RESIDENTIAL UNITS TO COMPLY WITH OREGON ACCESSIBILITY

ISSUES

 PHASE
 100% CD's

 DATE
 August 4th, 2023


 JOB NUMBER
 21-053-OR

MARK DATE DESCRIPTION

SHEET NAME

FLOOR PLAN -LEVEL 03

SHEET NUMBER

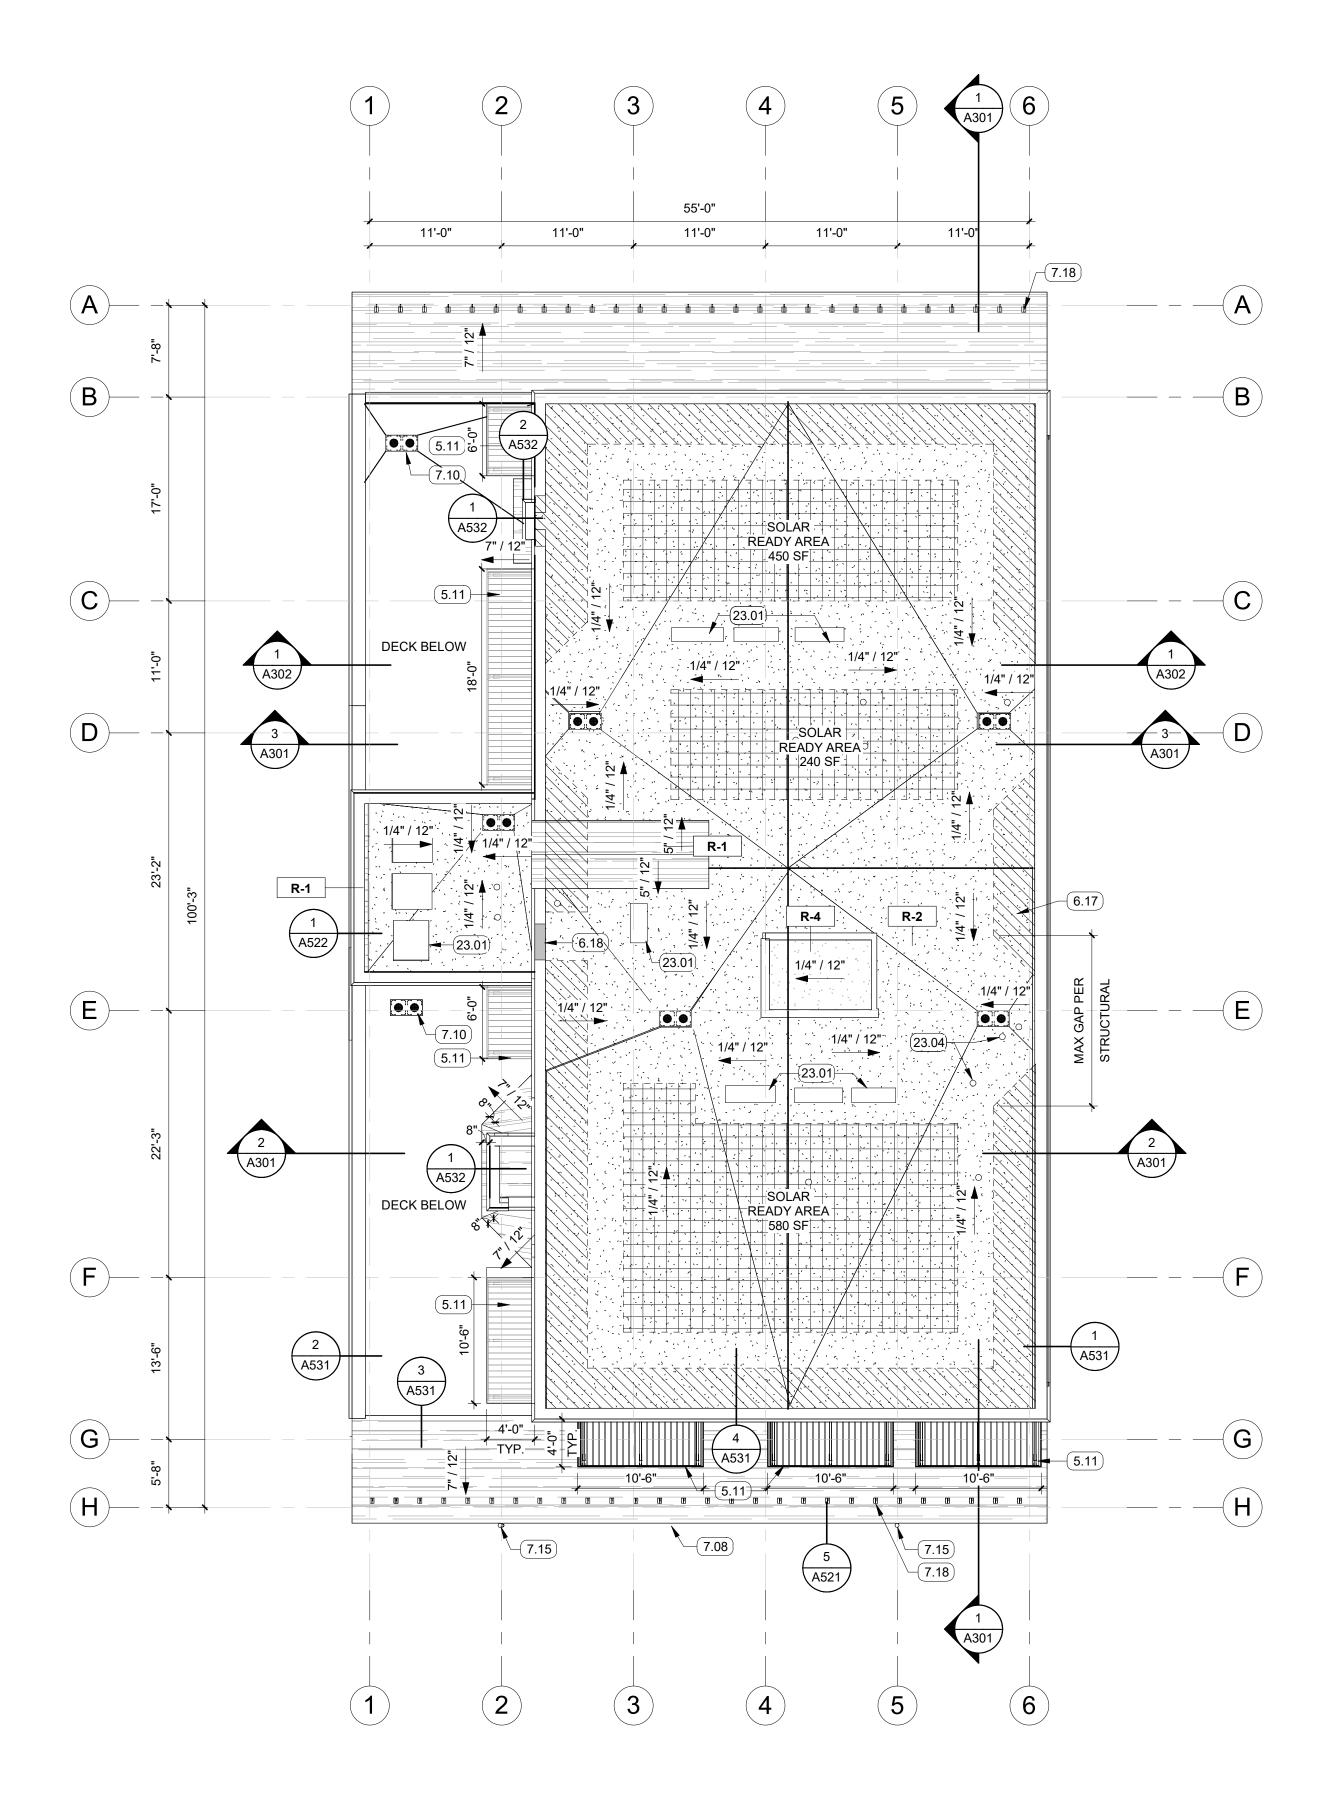

ROOF PLAN
SCALE: 1/8" = 1'-0"



KEYNOTES

- 5.11 ARCHITECTURAL ALUMINUM AWNING 6.17 KITCHERS, SEE STRUCTURAL
- 18 GATE WITH LATCH, FINISH TO MATCH SIDING
- 8 GUTTERS
- 7.10 ROOF DRAINS
- 7.15 ASHPALT COMP SHINGLES
- 7.18 PRO 100 SNOW GUARDS SGPRO100ASS AT 24" O.C. ALONG EAVE
- 23.01 MECHANICAL ROOFTOP EQUIPMENT
- 04 EXHAUST AIR DUCT

ROOF PLAN LEGEND



FLAT ROOF
SINGLE-PLY MEMBRANE
O/ PROTECTION BOARD
O/ R-38 MIN. RIGID INSUL
O/ VAPOR BARRIER
O/ SHTG, SEE STRL
O/ FRAMING, SEE STRL
O/ 1/2 RESILENT CHANNEL
O/ 5/8" GYPSUM BOARD



SLOPED ROOF
ASPHALT COMP SHINGLES
O/ HIGH-TEMP UNDERLAYMENT
O/ PLYWOOD
O/ FRAMING



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PROJECT INFORMATION

GENERAL NOTES

- A. COORDINATE INSTALLATION OF ROOFING WITH OTHER TRADES.
 REPORT ANY CONFLICTS WITH ITEMS INSTALLED BY OTHER TRADES
- B. ALL ROOF CURBS FOR NEW ROOFTOP EXHAUST FANS, HVAC UNITS AND CONDENSING UNITS SHALL HAVE CURB HEIGHTS THAT WILL ALLOW FOR A MINIMUM OF 8" BASE FLASHING HEIGHTS FOR THE ROOF SYSTEM.
- C. ALL PLUMBING VENTS SHALL EXTEND ABOVE THE FINISHED SURFACE OF THE ROOF SYSTEM AS REQUIRED TO PROVIDE FOR A MINIMUM OF 8" BASE FLASHING. PROVIDE FLASHING AROUND VENTS AND ROOF PENETRATIONS PER ROOFING MANUFACTURER RECOMMENDATIONS.
- D. PROVIDE 36" WIDE WALK PADS AROUND PERIMETER OF ALL MECHANICAL EQUIPMENT. PROVIDE 36" WIDE WALK PADS AROUND ALL ROOF HATCHES & 72"X72" PADS AT LADDERS.
- E. UNLESS NOTED OTHERWISE PROVIDE FIRESTONE UNI-CLAD KYNAR 500/HYLAR 5000 PRE-FINISHED GALVALUME STEEL (24 GA) ARCHITECTURE SHEET AND COIL FOR ALL COPINGS, FLASHING & TRIM PIECES. SUBMIT STANDARD COLOR SELECTION TO ARCHITECT FOR APPROVAL. FIELD PAINT METAL ONLY AS REQUIRED OR NOTED. ALL CLEATS TO BE CONTINUOUS.
- F. ALL DOWNSPOUTS TO BE PRE-FINISHED SMACNA APPROVED RECTANGULAR ALUMINUM DOWNSPOUT SIZED FOR QUANTITY OF WATER FLOW. PROVIDE ALUMINUM ATTACHMENT CLIPS AT MAX 4' INTERVALS. UNO PROVIDE HEAT CABLE IN DOWNSPOUT AND EXTEND INTO GROUND. UNO SUBMIT STANDARD COLOR SELECTION TO ARCHITECT FOR APPROVAL. SEE EXTERIOR ELEVATIONS OR ROOF PLAN FOR LOCATIONS.
- G. PROVIDE PAINTED 4' TALL CAST ALUM. DOWNSPOUT BOOTS @ ALL DOWN SPOUTS, TIE INTO SUB-GRADE DRAINAGE, RE: CIVIL.
- H. TAPERED INSULATION TO BE 1/4" PER FOOT MIN SLOPE TO DRAIN. ROOF PLAN SHOWS TAPERED INSULATION FOR GRAPHIC REPRESENTATION ONLY. CONTRACTOR TO VERIFY INSULATION REQUIRED TO SLOPE PRIOR TO MEMBRANE INSULATION.
- I. PROVIDE TAPERED INSULATION CRICKETS 1/4" PER FOOT MIN. SLOPE @ HIGH SIDE OF ALL MECHANICAL UNITS AND ROOF HATCHES, TO SHED WATER AROUND AND MAINTAIN POSITIVE ROOF DRAINAGE.
- J. VERIFY ELEVATION OF ROOF DRAIN RELATIVE TO OVERFLOW SCUPPER PRIOR TO INSTALLATION OF SCUPPER
- K. PROVIDE SELF-ADHERING VAPOR RETARDER BETWEEN DECK AND INSULATION, SEE DETAILS. UNO PROVIDE CARLISLE AIR & VAPOR BARRIER TR725. PROVIDE AIR TIGHT SEAL AROUND ALL DECK PENETRATIONS AND DECK PERIMETER PRIOR TO INSTALLING VAPOR BARRIER
- L. ALL WOOD NAILER AND BLOCKING TO BE TREATED. SECURE NAILERS PER FM GLOBAL 1-49 PERIMETER FLASHING REQUIREMENTS
- M. INSTALL MANUFACTURE'S RECOMMENDED PRESSURE-SENSITIVE RUSS STRIP ALONG ENTIRE ROOF PERIMETER AND AT PERIMETER OF ALL ROOF CURBS.
- N. WHEN APPLICABLE UNLESS NOTED OTHERWISE, USE CDX PLYWOOD FOR EXTERIOR APPLICATIONS AND BCD PLYWOOD FOR INTERIOR APPLICATIONS.

BAKER MIXED USE

130 E CASCADE AVENUE SISTERS OREGON 97759

 ISSUES

 PHASE
 100% CD's

 DATE
 August 4th, 2023


 JOB NUMBER
 21-053-OR

MARK DATE DESCRIPTION

SHEET NAME

ROOF PLAN

SHEET NUMBER

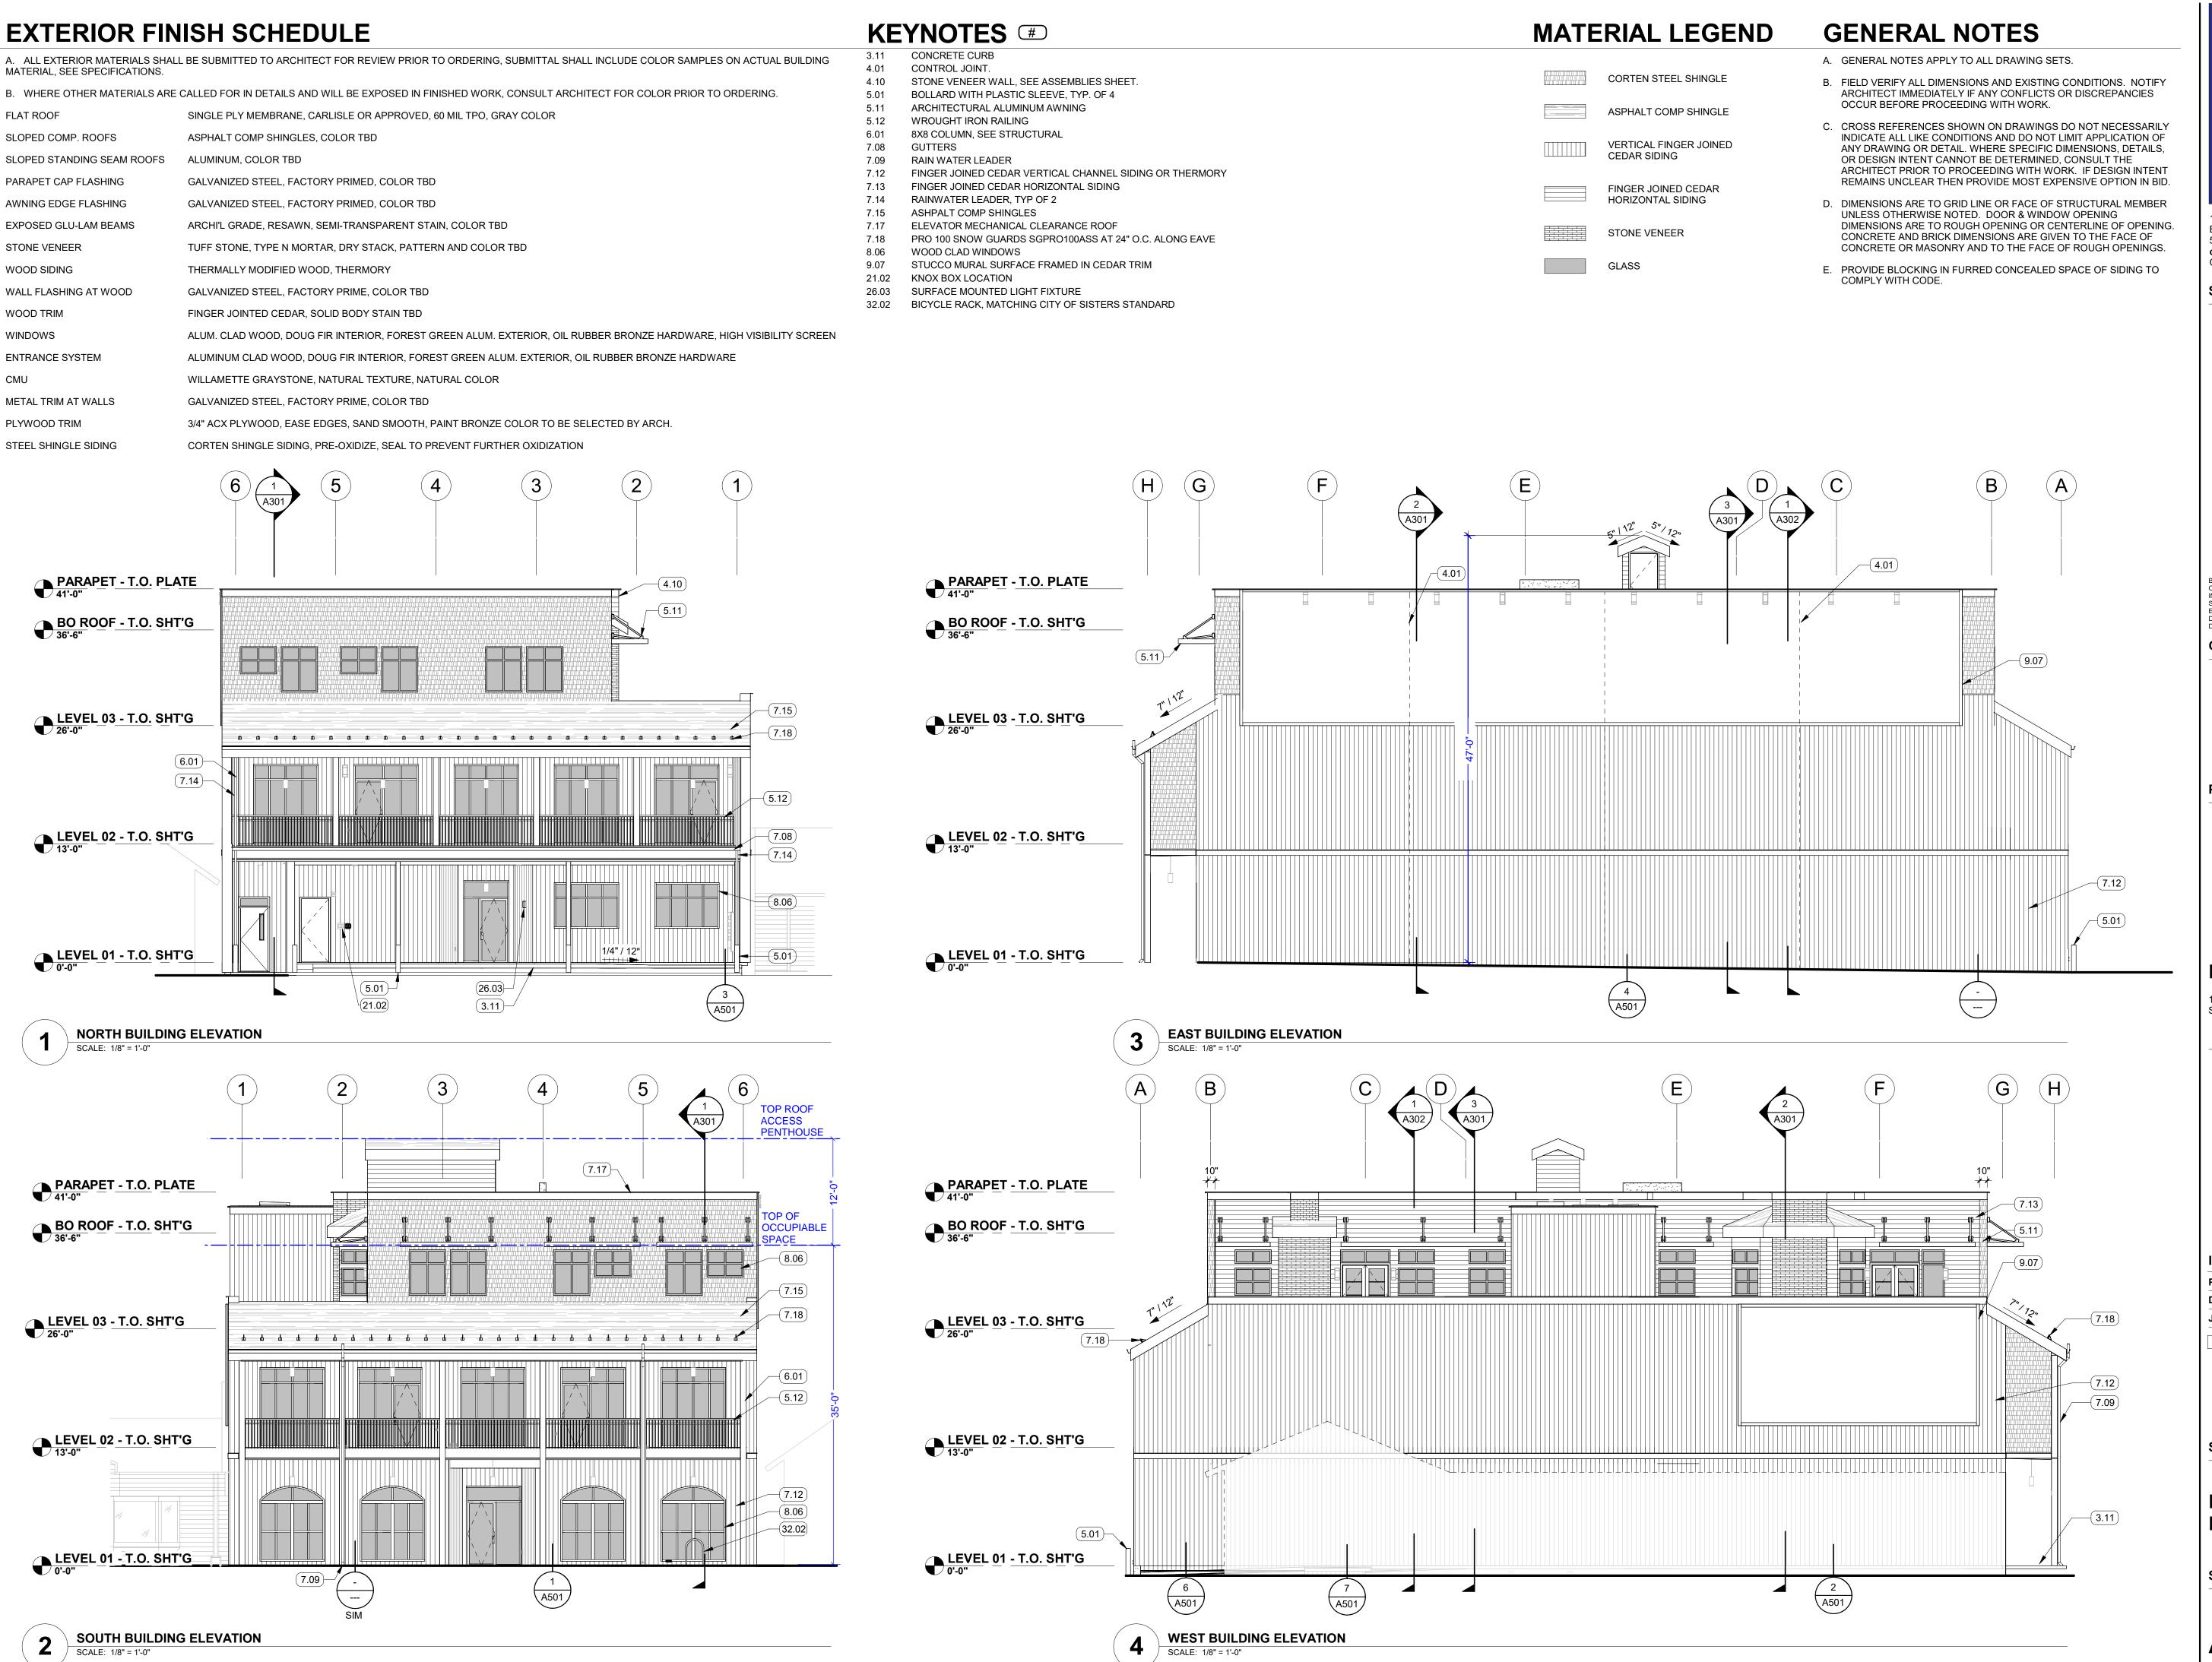

COLE /ARCHITECTS

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PROJECT INFORMATION

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130 E CASCADE AVENUE SISTERS OREGON 97759

ISSUES

HASE	100% CD's
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OB NUMBER	21-053-OR
MARK DATE	DESCRIPTION

SHEET NAME

EXTERIOR ELEVATIONS


SHEET NUMBER

BUILDING CONCEPT / IMAGERY







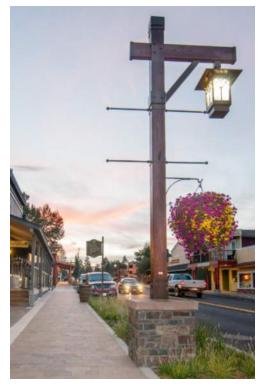










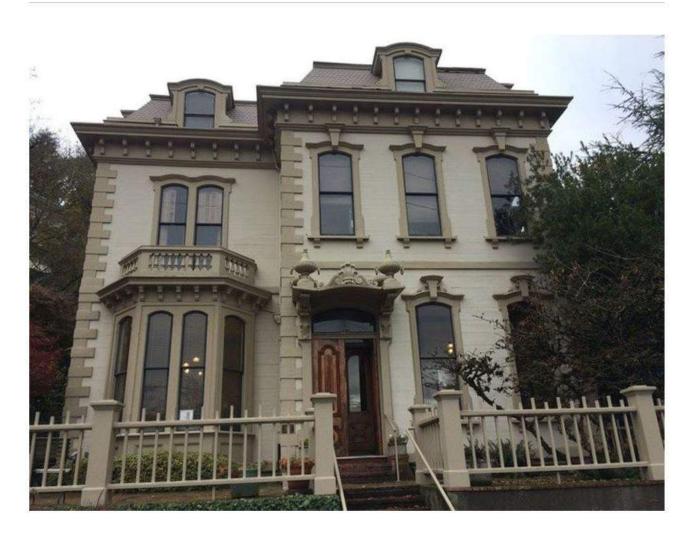

The Oregonian

1872 Jacob Kamm House

The Jacob Kamm house was originally built in 1871-2 at what is now Southwest 14th Avenue and Main Street -- land now occupied by Lincoln High School. The mansion, designed in the Second Empire style by architect Justus F. Krumbien, was moved in 1951 to its current location at 1425 S.W. 20th in Goose Hollow. Notice the Italianate polygonal bays, elongated windows and French-style mansard roof and quoins imitating stuccoed stone walls. It was placed on the National Register of Historic Places in 1974.






BENTON COUNTY COURTHOUSE - 120 NW 4th St, Corvallis, OR

The first courthouse was constructed in 1855. It was replaced in 1888-1889 by the present one, which is the oldest active courthouse in the state. The first one cost \$6,200, part of wich was withheld from the contractor because of poor workmanship. The present courtouse cost about \$70,000 and was financed by a two-mill levy. It was authorized in 1888, and constructed in 1888-1889. A new jail was built at the same time to the south of the courthouse. It cost an additional \$14,500. The original jail was succeeded by a single-story, tile-roofed structure on the north in 1929 and, more recently, by the single-story Corrections Wing of 1974-1976.



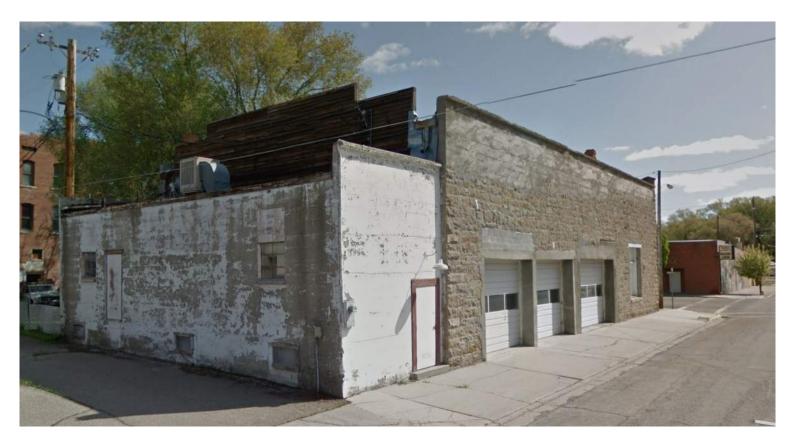

HOPE BROTHERS BUILDING - 187 Main St S, Vale, OR 97918


CONSTRUCTED 1893: One of the oldest buildings in town, it was built in 1893, by M.G. and I.W. Hope for their general mercantile store, replacing a frame building, which burned. It also served for a time as the post office. The Hopes sold their store and it became the first home of the Vale Trading company.

Remnants of aging stucco can be seen flaking off the stone walls. The more recent concrete addition was finished with stucco to match the existing conditions.



MALHEUR DRUG - 198 A St W, Vale, OR 97918

CONSTRUCTED 1906 - DESERT WESTERN THEME: This building was built as the headquarters for the Vale Forwarding Company in 1906, and for many years has been a drug store. It and the T. T. Nelson building are the only two buildings that have survived two major fires in this block

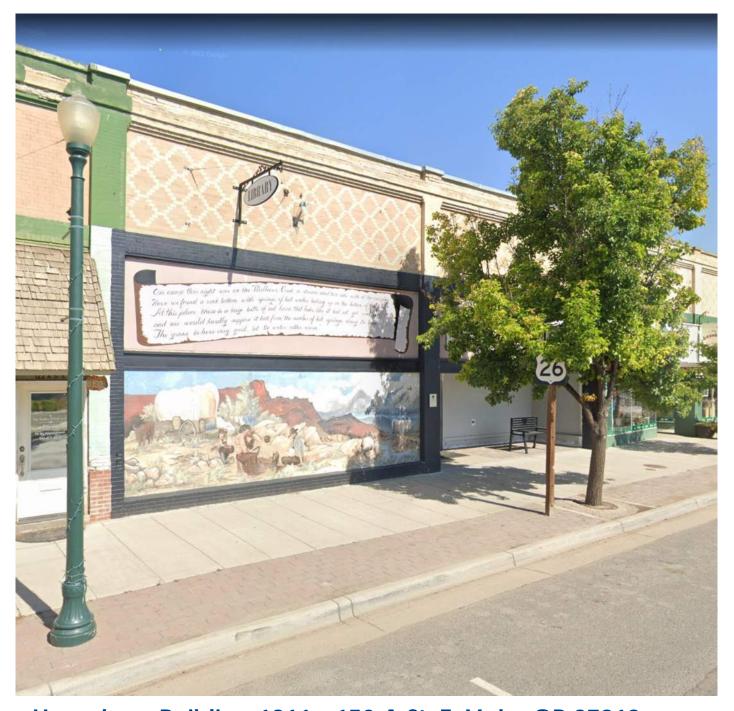

Humphrey Building 1911 - 150 A St. E, Vale, OR 97918

One of the several constructed during 1911, it was the Vale Hardware Store and a saddlery occupied by Billy Rose. L. K. Bullock operated an early garage and once when it had a hardwood floor it was the town's roller rink.

NOTE:

'BOARDWALK' LIGHTING' WILL BE IN ALCOVES BETWEEN STRUCTURE UNDER FRONT DECK AND WILL NOT PRODUCE EXCESSIVE GLARE ONTO STREET OR ADJACENT PROPERTIES.

GLAZING WILL COLOR LIGHT TO PRODUCE SOFT WARM TONES AND FIXTURE WILL DIRECT LIGHT DOWNWARD.


LIGHTBULBS WILL BE LED 60 WATT EQUIVELANT WITH 2700K COLOR.

(index.html) Lighting (lighting.html) Flush Mount Lighting Fixtures (flush-mount-lighting-fixtures.html)

Arroyo Craftsman Flush Mounts (arroyo-craftsman-flush-mount-lighting.html) GCM-8 Arroyo Craftsman 8" Glasgow Flush Ceiling Mount

(index.html) Shop by Brands (five-rivers-lighting-by-vendor.html) Arroyo Craftsman (arroyo-craftsman.html)

Arroyo Craftsman Flush Mounts (arroyo-craftsman-flush-mount-lighting.html) GCM-8 Arroyo Craftsman 8" Glasgow Flush Ceiling Mount

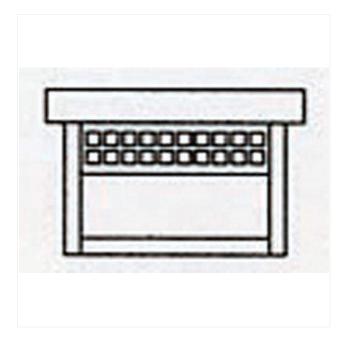

GCM-8 Arroyo Craftsman 8" Glasgow Flush Ceiling Mount

The Arroyo Craftsman GCM-8 8 inch Glasgow flush ceiling mount, measures 8 3/8 inches wide by 6 1/4 inches tall. It is rated for a damp location. It has two 60 watt medium incandescent base sockets. The mounting base is 9 3/4 inch square. This item ships through UPS or FedEx. All ten metal finish options are available. All ten glass options are available as well as blue-white opalescent (BC), gold white iridescent-white opalescent(GWC), and red-white opalescent (REC) combinations.

\$561.00 \$374.00

Qty	_	1	+	ADD TO CART	
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FREE SHIPPING

UPS/FedEx orders over \$75

(fiverivers-shipping-policy.html)

Part Number

Brand

Collection

Category

Specifications

UPC

Availability

- : GCM-8
- : Arroyo Craftsman
- : Glasgow
- : Flush Mounts and Semi-Flush Mounts

 $: 6.25 \rm H~X~8.38 W~In ches~Mounting~Base~Is~9.75~In ches~Square~Two~60~Watt~Medium~Sockets~In can descent~Light~Suitable~For~Damp~Location~Shipped~via~UPS~Note:~When~choosing~glass,~Amber~Mica~and~Almond~Mica~are~not~recommended~for~outdoor~use.$

- : '753174650655
- : Usually ships in 8 to 12 weeks

ፒክፍ ሲተያርያ vo Craftsman GCM-8 8 inch Glasgow flush ceiling mount, measures 28 (3/8 inches wide by 6 1/4 inches tall. It is rated for a damp location. It has two 60 watt medium incandescent base sockets. The mounting base is 9 3/4 inch square. This item ships through UPS or FedEx. All ten metal finish options are available. All ten glass መውጀመር as well as blue-white opalescent (BC), gold white iridescent-white opalescent (GWC), and red-white opalescent (REC) combinations.


Five Rivers

View Less Detail

(index.html)

Click on Option Image to Select Your Options



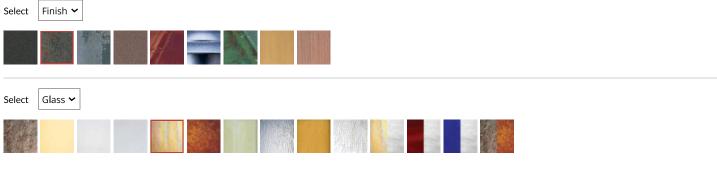


Related Items



(arc-gb-18.html)

GB-18 Arroyo Craftsman 18" Glasgow Wall Mount (arc-gb-18.html)

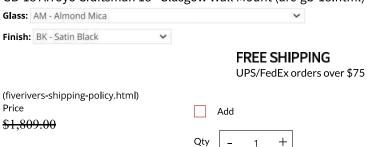



(4.85" with Up-Light)

VCPG LED Parking Garage








Specifications


Diameter: 19"


Height: 3.75"


Weight 18 lbs

(max, with no options):

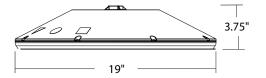

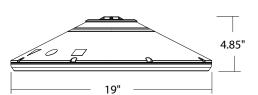

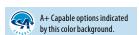

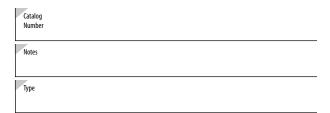

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Introduction

The all new VCPG LED (Visually Comfortable Parking Garage) luminaire is designed to bring glare control, optical performance and energy savings into one package. The recessed lens design of VCPG LED minimizes high angle glare, while its precision molded acrylic lens eliminates LED pixilation and delivers the required minimums, verticals and uniformity. The dedicated up-light module option reduces the contrast between the luminaire and the ceiling creating a more visually comfortable environment.

The VCPG LED delivers up to 87% in energy savings when replacing 175W metal halide luminaires. With over 100,000 hour life expectancy (12+ years of 24/7 continuous operation), the VCPG LED luminaire provides significant maintenance savings over traditional luminaires.

Ordering Information

EXAMPLE: VCPG LED V4 P4 40K 70CRI T5M MVOLT SRM DNAXD

VCPG LED											
Series	LED Li Engin		Package	Color temperature	Color Rendering Index	Distrib	tribution Voltage Mounting		Voltage		ing
VCPG LED	V4 ¹	4 Light Engines 8 Light Engines	P1 ¹ P2 ¹ P3 ¹ P4 ¹ P5 ¹ P6 ¹ P7 ¹	30K 3000 K 35K 3500 K 40K 4000 K 50K 5000 K	70CRI 80CRI	T5M T5R² T5W T5E LANE²	Type V, medium Type V, rectangular Type V, wide Type V entry Drive lane	MVOLT 347 480	For ordering with fuse 120 208 240 277 347 480	PM SRM ARM	Peed included Pendant mount standard (24-inch length supply leads) Surface mount (24-inch length supply leads) Arm mount (use RSXWBA accessory to mount to a wall) Peed separately Yoke/trunnion mount ³

Options				Finish (required)			
Shipped ins	stalled	Standalone Sens	ors/Controls ²	DWHXD White			
UPL1	Up-Light: 500 lumens	PIR	Motion/ambient sensor for 8-15' mounting heights	DNAXD Natural aluminum			
UPL2	Up-Light: 700 lumens	PIRH	Motion/ambient sensor for 15-30' mounting heights	DDBXD Dark bronze			
E8WC	Emergency battery backup, Certified in CA Title 20 MAEDBS (8W, -20°C min) ^{4,5,6}	PIR3FC3V	Motion/ambient sensor for 8-15' mounting heights, pre programmed	DBLXD Black			
E10WH	Emergency battery backup, Certified in CA Title 20 MAEDBS (10W, 5°C min) ^{4,5,6}		to 3fc and 35% light output				
HA	High ambient (50°C, only P1-P4)	PIRH3FC3V	Motion/ambient sensor for 15-30' mounting heights, pre programmed to 3fc and 35% light output	Note: Product will be shipped			
SF	Single fuse (120V, 277V, 347V)		to sic and 3370 light output	in job packs of 18pcs per box. The remaining units will be			
DF							
SPD10KV	10KV Surge Pack	NLTAIR2 PIR	shipped in unit packs.				
LDS36	36in (3ft) lead length	NLIAINZ FIN	nLIGHT AIR Wireless enabled motion/ambient sensor for 8–15' mounting heights				
LDS72	72in (6ft) lead length	NLTAIR2 PIRH	nLIGHT AIR Wireless enabled motion/ambient sensor for 15'-30'				
LDS108	108in (9ft) lead length		mounting heights				
DMG	External 0-10V leads (no controls) ⁷	NLTAIR2 PIR924	nLIGHT AIR Wireless enabled, UL924 Listed motion/ambient sensor for				
TP	Tamper proof screws	NUTAIDA DIDUGA	8-15' mounting heights 8				
Shipped Se	parately	NLTAIR2 PIRH924	nLIGHT AIR Wireless enabled, UL924 Listed motion/ambient sensor for 15'-30' mounting heights ⁸				
WG	Wire Guard		15 50 mounting neighb				
BDS	Bird Shroud						
HS	House Side Shield						
BSW	Bird Spikes						



GLAZING WILL COLOR LIGHT TO PRODUCE SOFT WARM TONES AND WILL DIRECT LIGHT **DOWNWARD**

LIGHTBULBS WILL BE LED 60 WATT EQUIVELANT WITH 2700K COLOR

Home / Lighting Manufacturers / Arroyo Craftsman / Arroyo Craftsman Pendants / Arroyo Craftsman EH-7 Evergreen Craftsman Indoor/Outdoor Hanging Pendant Light - 7 inches wide



Arroyo Craftsman EH-7 Evergreen Craftsman Indoor/Outdoor Hanging Pendant Light - 7 inches wide

by Arroyo Craftsman Item# ARR-EH-7

Overlay: T-Bar - T












Glass: Gold White Iridescent - GW





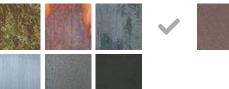





Subtotal of selected item(s)

\$392.40

\$436.00 (You Save 10%)

Availability: Please allow 16 to 20 weeks for delivery; all Arroyo Craftsman fixtures are custom made in the USA and cannot be returned.



Qty: **1**

Add to Cart



10% Off Entire Inventory! *Limited Time Offer*

Prices Already Reduced







Product Specification

The Evergreen hanging pendant light brightens your entryway or patio with a craftsman lantern, fusing Swiss Chalet, English Tudor, and California Mission styles. Various metal finish, glass shade, and filigree/overlay options available to meet your decorating needs. More light fixtures available from the same family.

- 7" Width
- 9.5" Height
- 45.5" Hang from ceiling
- Uses (1) 100 watt incandescent bulbs, not included
- Antique Brass and Antique Copper finishes recommended for indoor use only
- Please note: Mica options are not recommended for outdoor use and should only be used with sixty watt maximum bulbs to prevent warping.
- · A product of American Lighting Brands
- Made in the USA